


# RED BARN PROPERTY LLC 210 PORTSMOUTH AVENUE STRATHAM, NH TAX MAP 21 LOT 81

CIVIL ENGINEERS:



70 PORTSMOUTH AVE,  
THIRD FLOOR, SUITE 2  
STRATHAM, N.H. 03885  
PHONE: 603-583-4860,

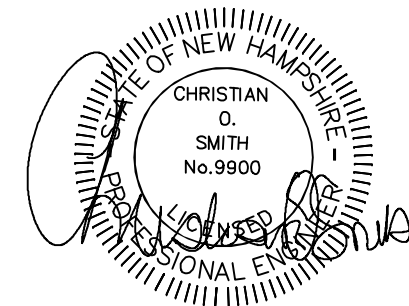

LAND SURVEYORS:




686 Central Ave, Ste 100, Dover NH 03820 (603) 953-3164 www.northamsurvey.com

WETLAND CONSULTANT:

SERGIO BONILLA, CWS #261  
MISSION WETLAND & ECOLOGICAL SERVICES  
PO BOX 4028  
PORTSMOUTH, NH 03802  
603-361-3204

SOIL CONSULTANT:

LUKE HURLEY, CSS  
HURLEY ENVIRONMENTAL AND LAND PLANNING, LLC  
PO BOX 356  
EPSOM, NH 03234  
603-583-1745

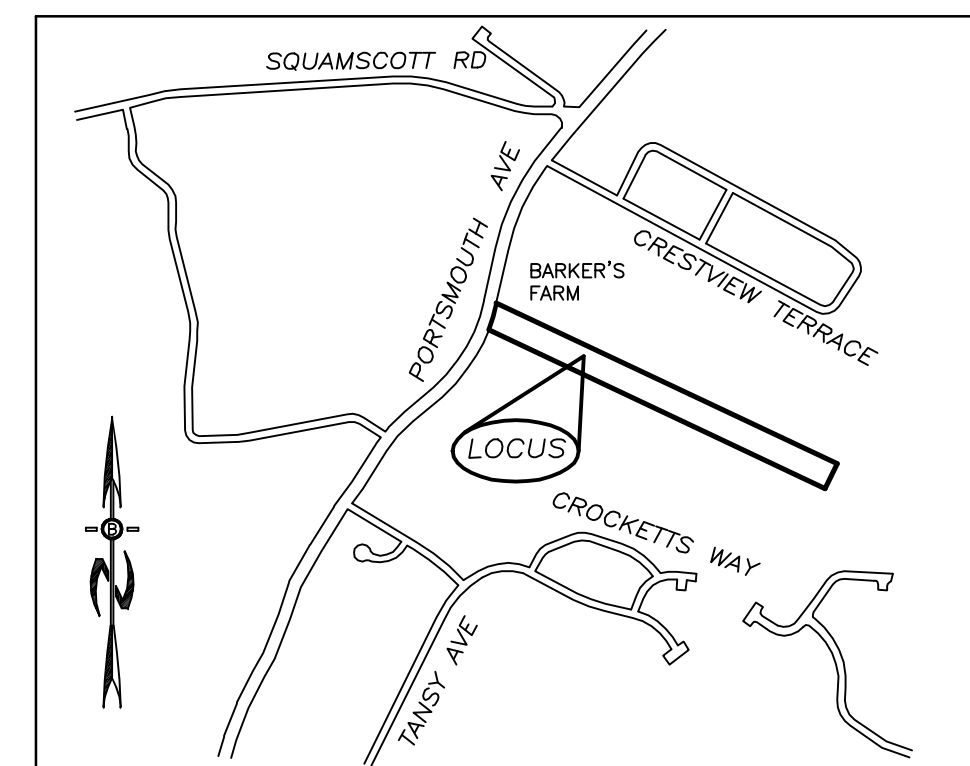

LOCATION MAP  
NTS

OWNER/APPLICANT  
RED BARN PROPERTY LLC  
BRENDAN SHEEHAN  
6 SHORE DRIVE  
GREENLAND, NH 03840  
RCRD BOOK 6543, PAGE 1271

PLAN SET LEGEND

5/8" REBAR	●	DRAINAGE LINE	—○—○—
DRILL HOLE	○	OVERHEAD ELEC. LINE	—OHE—
CONC. BOUND	□	STONE WALL	—○—○—
UTILITY POLE	⊕	TREE LINE	—wavy—
DRAIN MANHOLE	⊙	SOIL LINES	—dotted—
EXISTING LIGHT POLE	⊛	WETLAND SETBACK	—dashed—
EXISTING CATCH BASIN	⊞	BUILDING SETBACK LINES	—long dashed—
PROPOSED CATCH BASIN	⊟	EXIST. CONTOUR	—100—
PINES, ETC.	⊙	PROP. CONTOUR	—100—
MAPLES, ETC.	⊙	ABUT. PROPERTY LINES	—long dashed—
EXIST. SPOT GRADE	⊙	EXIST. PROPERTY LINES	—long dashed—
SINGLE POST SIGN	⊙	PROP. PROPERTY LINES	—long dashed—
4000 SF SEPTIC RESERVE AREA	⊙	PROP. WELL W/ 75' PROTECTIVE RAD.	⊙

INDEX

TITLE SHEET

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DETAIL PLANS . . . . .	10
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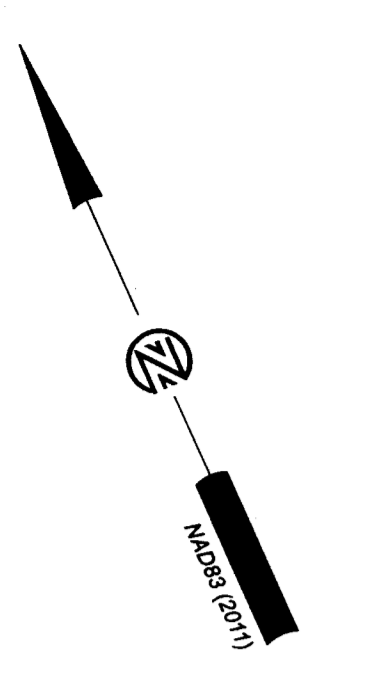
REQUIRED STATE & FEDERAL PERMITS

NHDES - INDIVIDUAL SEWAGE DISPOSAL SYSTEM . . . . .	PENDING SUBMITTAL
NHDES - WETLANDS BUREAU DREDGE & FILL . . . . .	PENDING SUBMITTAL
NHDOT - DRIVEWAY PERMIT . . . . .	SUBMITTED
CONSTRUCTION GENERAL PERMIT . . . . .	PENDING SUBMITTAL

APPROVAL BLOCK

APPROVED TOWN OF STRATHAM PLANNING BOARD	
CHAIRPERSON	DATE


REVISIONS:	DATE:
ISSUED	MAR 11, 2026
REVISED PER REVIEW COMMENTS	MAY 5, 2026



**NOTES:**

- SUBJECT PARCEL: TAX MAP 21 LOT 81  
210 PORTSMOUTH AVE  
STRATHAM, NH  
NS PROJECT #1019
- OWNER OF RECORD: RED BARN PROPERTY LLC  
6 SHORE DRIVE  
GREENLAND, NH 03840  
R.C.R.D. BOOK 6543, PAGE 1271
- PARCEL AREA: 484,172 S.F. OR 11.12 AC
- THE PURPOSE OF THIS PLAN IS TO SHOW EXISTING CONDITIONS OF THE SUBJECT PARCEL.
- DIMENSIONAL REQUIREMENTS:**

MIN LOT AREA:	1 ACRE
MIN LOT FRONTAGE:	200'
MAX LOT FRONTAGE:	30'
MIN FRONT SETBACK:	WITHIN 10' OF AVERAGE OF EXISTING SETBACKS/ MAX 35'
MIN SIDE/REAR SETBACK:	20'
MAX BUILDING HEIGHT:	35'
MAX BUILDING FOOTPRINT:	10,000 S.F.
MAX BUILDING COVERAGE:	20%
MIN OPEN SPACE/LOT:	60%



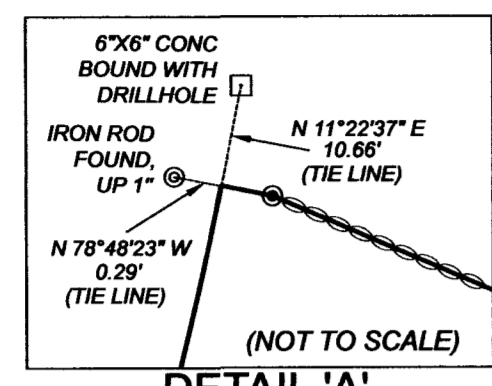


**NOTES CONTINUED:**

- ZONING INFORMATION SHOWN HEREON IS PER THE TOWN OF STRATHAM ZONING ORDINANCE DATED MARCH 1987 LAST REVISED MARCH 2025. ADDITIONAL REGULATIONS APPLY, THE LAND OWNER IS RESPONSIBLE FOR COMPLYING WITH ALL APPLICABLE TOWN, STATE, AND FEDERAL REGULATIONS.
- FLOOD HAZARD ZONE: "X" WITH NO BASE FLOOD ELEVATION, PER FIRM MAP #33015C0245F, WITH AN EFFECTIVE DATE OF JANUARY 29, 2021.
- THE INTENT OF THIS PLAN IS TO SHOW THE LOCATION OF BOUNDARIES IN ACCORDANCE WITH THE CURRENT LEGAL DESCRIPTIONS. IT IS NOT AN ATTEMPT TO DEFINE UNWRITTEN RIGHTS, DETERMINE THE EXTENT OF OWNERSHIP, OR DEFINE THE LIMITS OF TITLE.
- FIELD SURVEY COMPLETED BY NORTHAM SURVEY IN JANUARY AND FEBRUARY 2025 USING A TRIMBLE S5 TOTAL STATION WITH A TRIMBLE TSC3 DATA COLLECTOR, A TRIMBLE R12 GPS RECEIVER AND A SOKKIA B31 AUTO LEVEL.
- HORIZONTAL DATUM IS NAD83(2011) NEW HAMPSHIRE STATE PLANE COORDINATES PER STATIC GPS OBSERVATIONS.
- THE VERTICAL DATUM IS NAVD88 PER STATIC GPS OBSERVATIONS. THE CONTOUR INTERVAL IS 2'. CONTOUR INFORMATION SHOWN HEREON IS PER PUBLIC LIDAR DATA 2019-2020 USGS LIDAR: NH COASTAL (QL1) PROCESSED AND DOWNLOADED FROM THE NOAA OFFICE FOR COASTAL MANAGEMENT.

**NOTES CONTINUED:**

- EASEMENTS, RIGHTS, AND RESTRICTIONS SHOWN OR IDENTIFIED ARE THOSE WHICH WERE FOUND DURING RESEARCH PERFORMED AT THE ROCKINGHAM COUNTY REGISTRY OF DEEDS. OTHER RIGHTS, EASEMENTS, OR RESTRICTIONS MAY EXIST WHICH A TITLE EXAMINATION OF SUBJECT PARCEL(S) WOULD DETERMINE.
- WETLAND DELINEATION CONDUCTED BY SERGIO BONILLA, NEW HAMPSHIRE STATE CERTIFIED WETLAND SCIENTIST (#261) ON 11/14/2025 IN ACCORDANCE WITH THE UNITED STATES ARMY CORPS OF ENGINEERS WETLANDS DELINEATION MANUAL, TECHNICAL REPORT Y-87-1 (JANUARY 1987), AND THE REGIONAL SUPPLEMENT TO THE CORPS OF ENGINEERS WETLAND DELINEATION MANUAL: NORTHCENTRAL AND NORTHEAST REGION (VERSION 2-TR-12-1, JANUARY 2012).
- THIS SURVEY WAS CONDUCTED IN WINTER CONDITIONS. SOME SITE FEATURES MAY HAVE BEEN OBSCURED DUE TO SNOW. A SPRING TIME SITE WALK IS RECOMMENDED TO VERIFY EXISTING CONDITIONS.

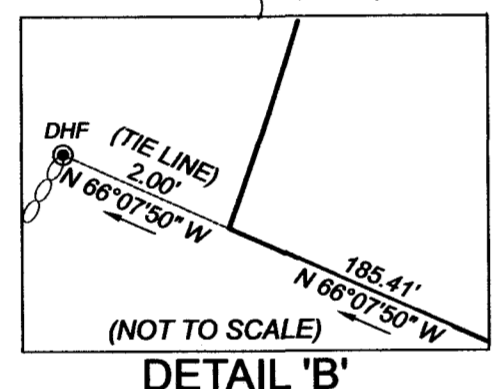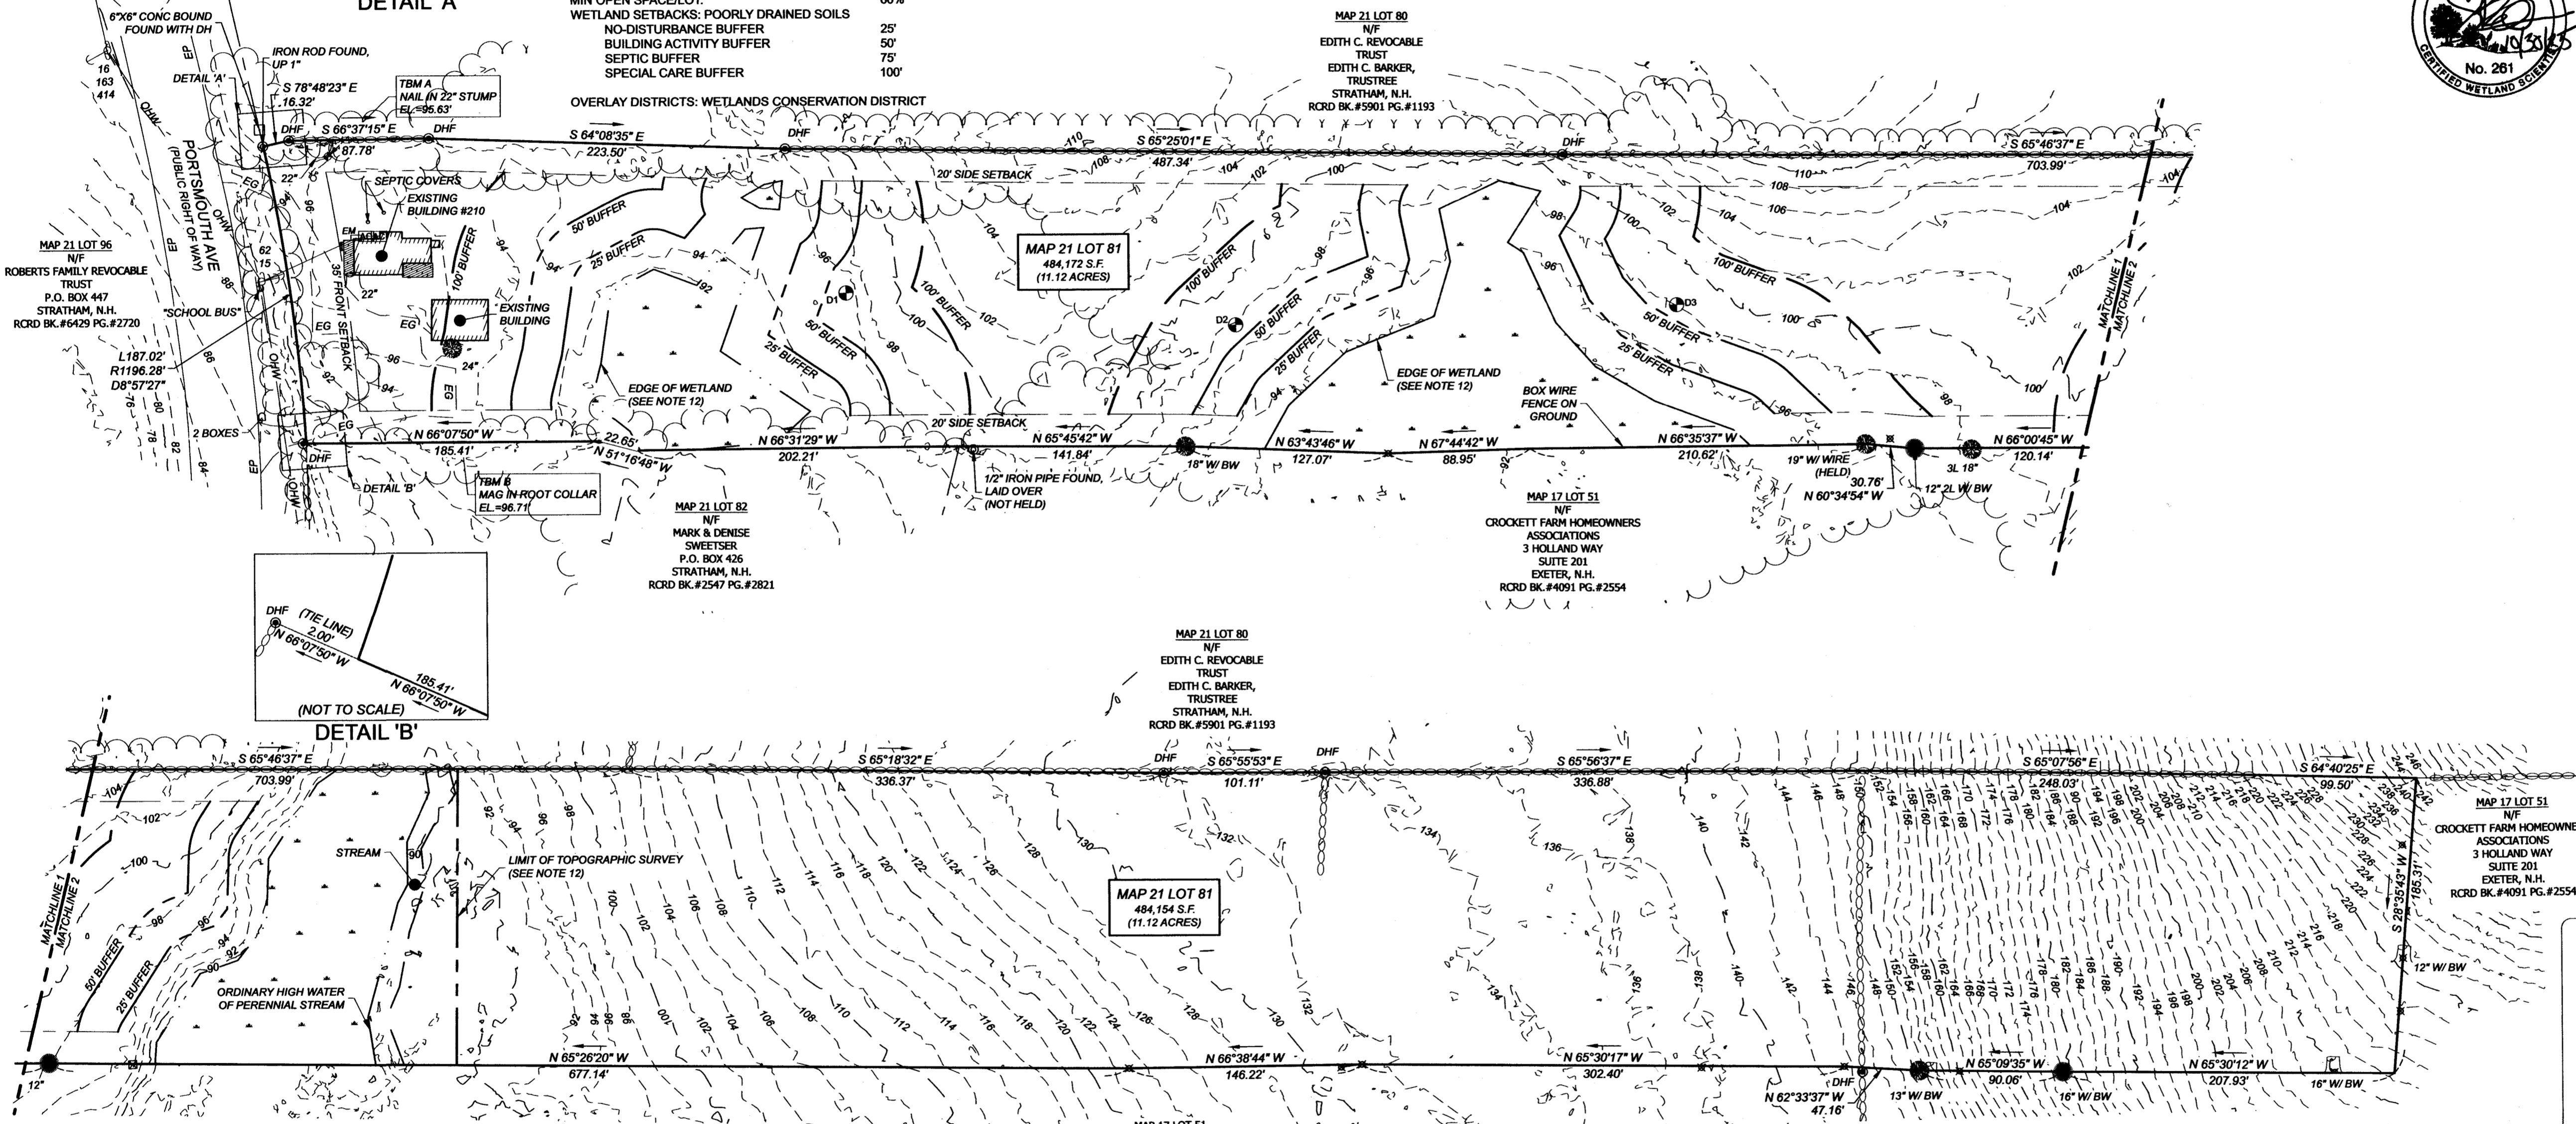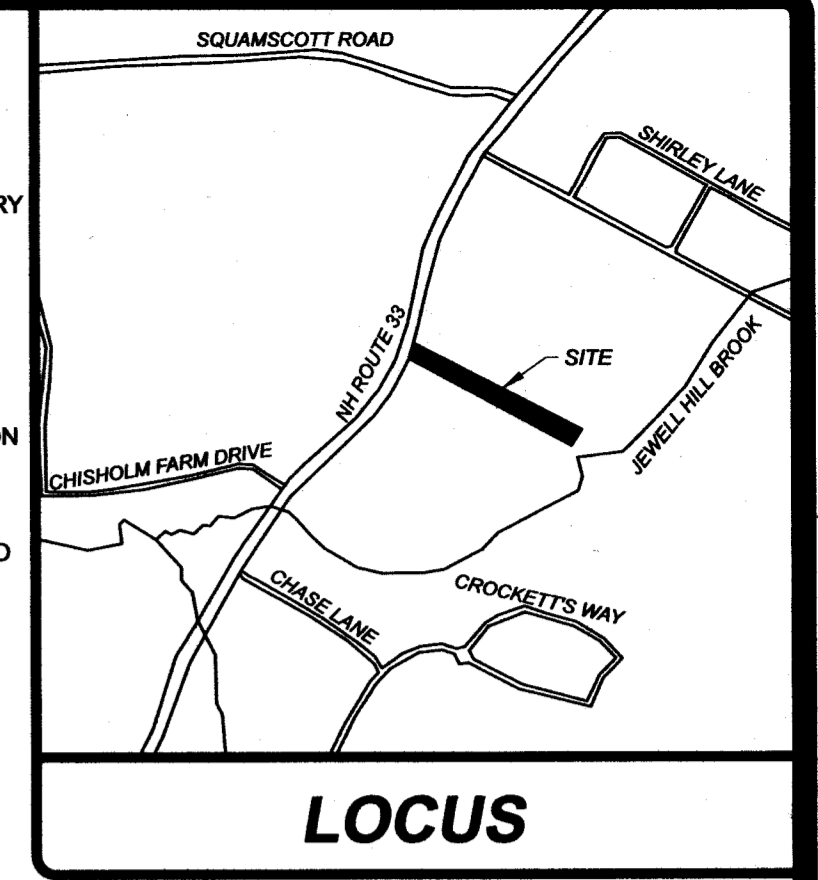

**LEGEND:**

MAP 137 LOT 11	ASSESSORS MAP AND LOT NUMBER
BK. PG. CONC.	BOOK / PAGE CONCRETE
DHF	DRILL HOLE FOUND
EM	ELECTRIC METER
EP	EDGE OF PAVEMENT
EG	EDGE OF GRAVEL
N/F	NOW OR FORMERLY
RCRD	ROCKINGHAM COUNTY REGISTRY OF DEEDS
S.F.	SQUARE FEET
TBM	TEMPORARY BENCHMARK
BW	BARBED WIRE
⊙	DRILL HOLE FOUND/SET
⊙	IRON PIPE/ROD FOUND
⊙	BOUND FOUND
⊙	SPIKENAIL FOUND
⊙	BARBED WIRE ON GROUND
⊙	AIR CONDITIONER
⊙	UTILITY POLE
⊙	ELECTRIC BOX
⊙	MAILBOX
⊙	VENT PIPE
⊙	POST
⊙	STUMP
⊙	CONIFEROUS TREE
⊙	DECIDUOUS TREE
⊙	TEMPORARY BENCHMARK SIGN
⊙	OVERHEAD WIRE
⊙	BOX WIRE FENCE
⊙	BOUNDARY LINE
⊙	SETBACK LINE
⊙	EXISTING CONTOUR
⊙	STONEWALL
⊙	EDGE OF WETLAND
⊙	WETLAND SETBACK
⊙	SPECIAL CARE BUFFER
⊙	CONCRETE
⊙	WETLANDS
⊙	BRICK
⊙	WOODEN DECK
⊙	TEST PITS



**EXISTING CONDITIONS FOR RED BARN PROPERTY LLC OF TAX MAP 21 LOT 81 210 PORTSMOUTH AVE STRATHAM, NH COUNTY OF ROCKINGHAM**

SCALE: 1"=60' (22x34) 1"=120' (11x17)

JOB NO.	1019	DATE:	2025-04-25
DRAWN BY:	EEC JIR TJD TJR	DRAWING:	1019 SURVEY.DWG
CHECKED BY:	EJS	SHEET:	1 OF 1
NO.	DATE	DESCRIPTION	BY
1	2025/10/30	UPDATED ZONING INFORMATION	TJR


- PLAN REFERENCES:**
- "SUBDIVISION OF LAND FOR WENDELL E. SWEETSER IN STRATHAM, N.H.", PREPARED BY PARKER SURVEY ASSOC., INC. DATED MARCH, 1985. RECORDED IN THE R.C.R.D. AS PLAN D-13677.
  - "SUBDIVISION MASTER PLAN JEWETT HILL STRATHAM, NH", PREPARED BY ON-SITE DESIGN & ENGINEERING. DATED APRIL 7, 1987. LAST REVISED JUNE 17, 1987. RECORDED IN THE R.C.R.D. AS PLAN D-17840.
  - "SUBDIVISION PLAT BARKER'S FARM PROPERTY OF CARL WARREN & GRACE BARKER ROUTE 101, STRATHAM, N.H.", PREPARED BY JOHN C. KELLER, LLS. DATED NOVEMBER 1992. RECORDED IN THE R.C.R.D. AS PLAN D-22025.
  - "PLAN OF LAND FOR WENDELL E. SWEETSER PORTSMOUTH AVENUE STRATHAM, NH", PREPARED BY O'NEIL SURVEY AND ASSOCIATES. DATED JULY 25, 1999. RECORDED IN THE R.C.R.D AS PLAN D-27363.
  - "LOT CONSOLIDATION PLANS THE HILLS AT CROCKETT FARM", PREPARED BY CAMMETT ENGINEERING. DATED JANUARY 03, 2003. RECORDED IN THE R.C.R.D AS PLAN D-30627.
  - "SUBDIVISION PLANS THE HILLS AT CROCKETT FARM", PREPARED BY CAMMETT ENGINEERING. DATED SEPTEMBER 20, 2002, LAST REVISED APRIL 14, 2003. RECORDED IN THE R.C.R.D AS PLAN D-30685.

PURSUANT TO NEW HAMPSHIRE RSA 678:18 III  
I CERTIFY THAT THIS SURVEY PLAT IS NOT A SUBDIVISION PURSUANT TO THIS TITLE AND THAT THE LINES OF STREETS AND WAYS SHOWN ARE THOSE OF PUBLIC OR PRIVATE STREETS OR WAYS ALREADY ESTABLISHED AND THAT NO NEW WAYS ARE SHOWN.  
I CERTIFY THAT THIS SURVEY AND PLAN WERE PREPARED BY ME OR THOSE UNDER MY DIRECT SUPERVISION. THIS SURVEY CONFORMS TO THE ACCURACY REQUIREMENTS OF AN URBAN SURVEY OF THE NEW HAMPSHIRE CODE OF ADMINISTRATIVE RULES OF THE BOARD OF LICENSURE FOR LAND SURVEYORS.  
I FURTHER CERTIFY THAT THIS SURVEY WAS MADE ON THE GROUND AND IS CORRECT TO THE BEST OF MY PROFESSIONAL KNOWLEDGE. RANDOM TRAVERSE SURVEY BY TOTAL STATION WITH A PRECISION GREATER THAN 1:15,000.

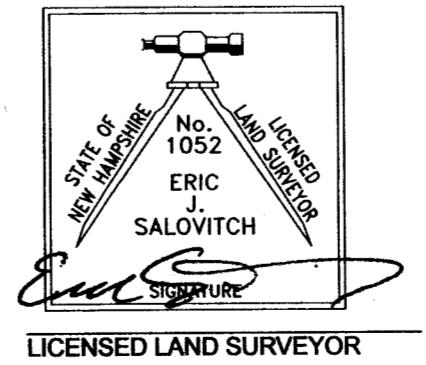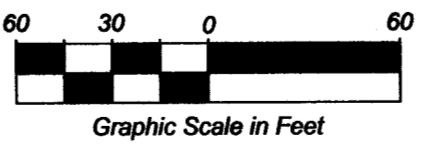

OCTOBER 30, 2025 DATE



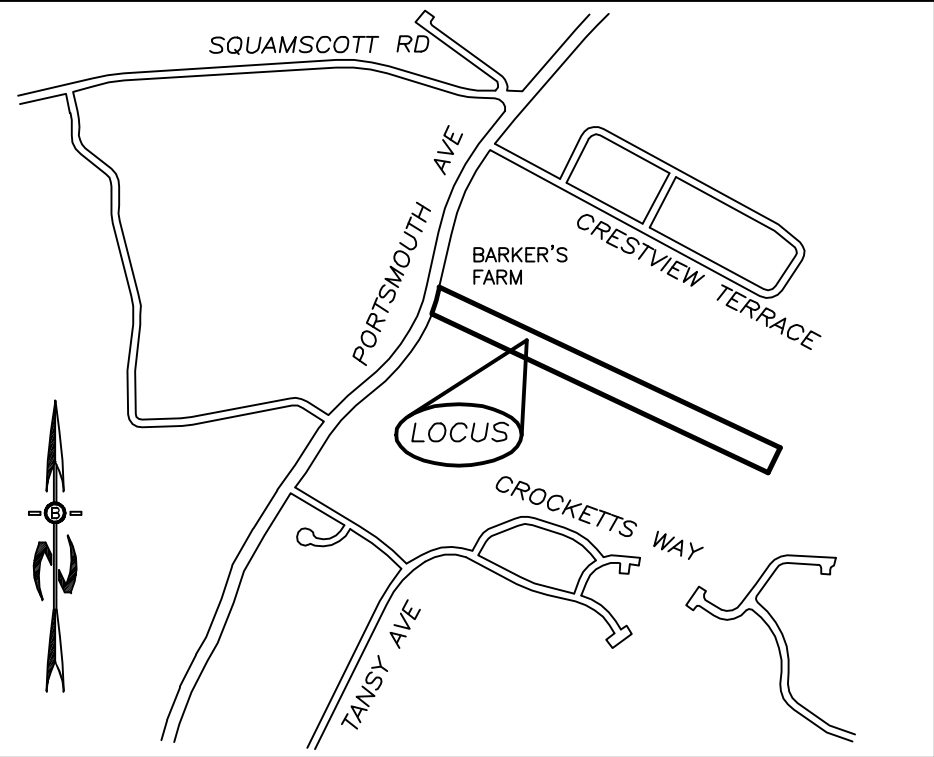




LOCATION MAP  
NTS

PREPARED FOR:

RED BARN PROPERTY LLC  
6 SHORE DRIVE  
GREENLAND, NH 03840



70 PORTSMOUTH AVE,  
THIRD FLOOR, SUITE 2  
STRATHAM, N.H. 03885  
PHONE: 603-583-4860.

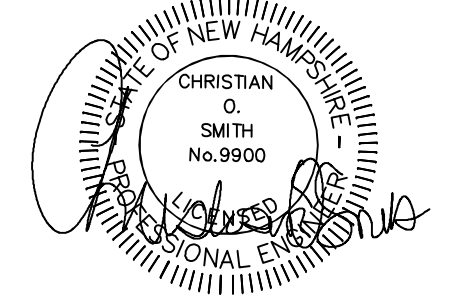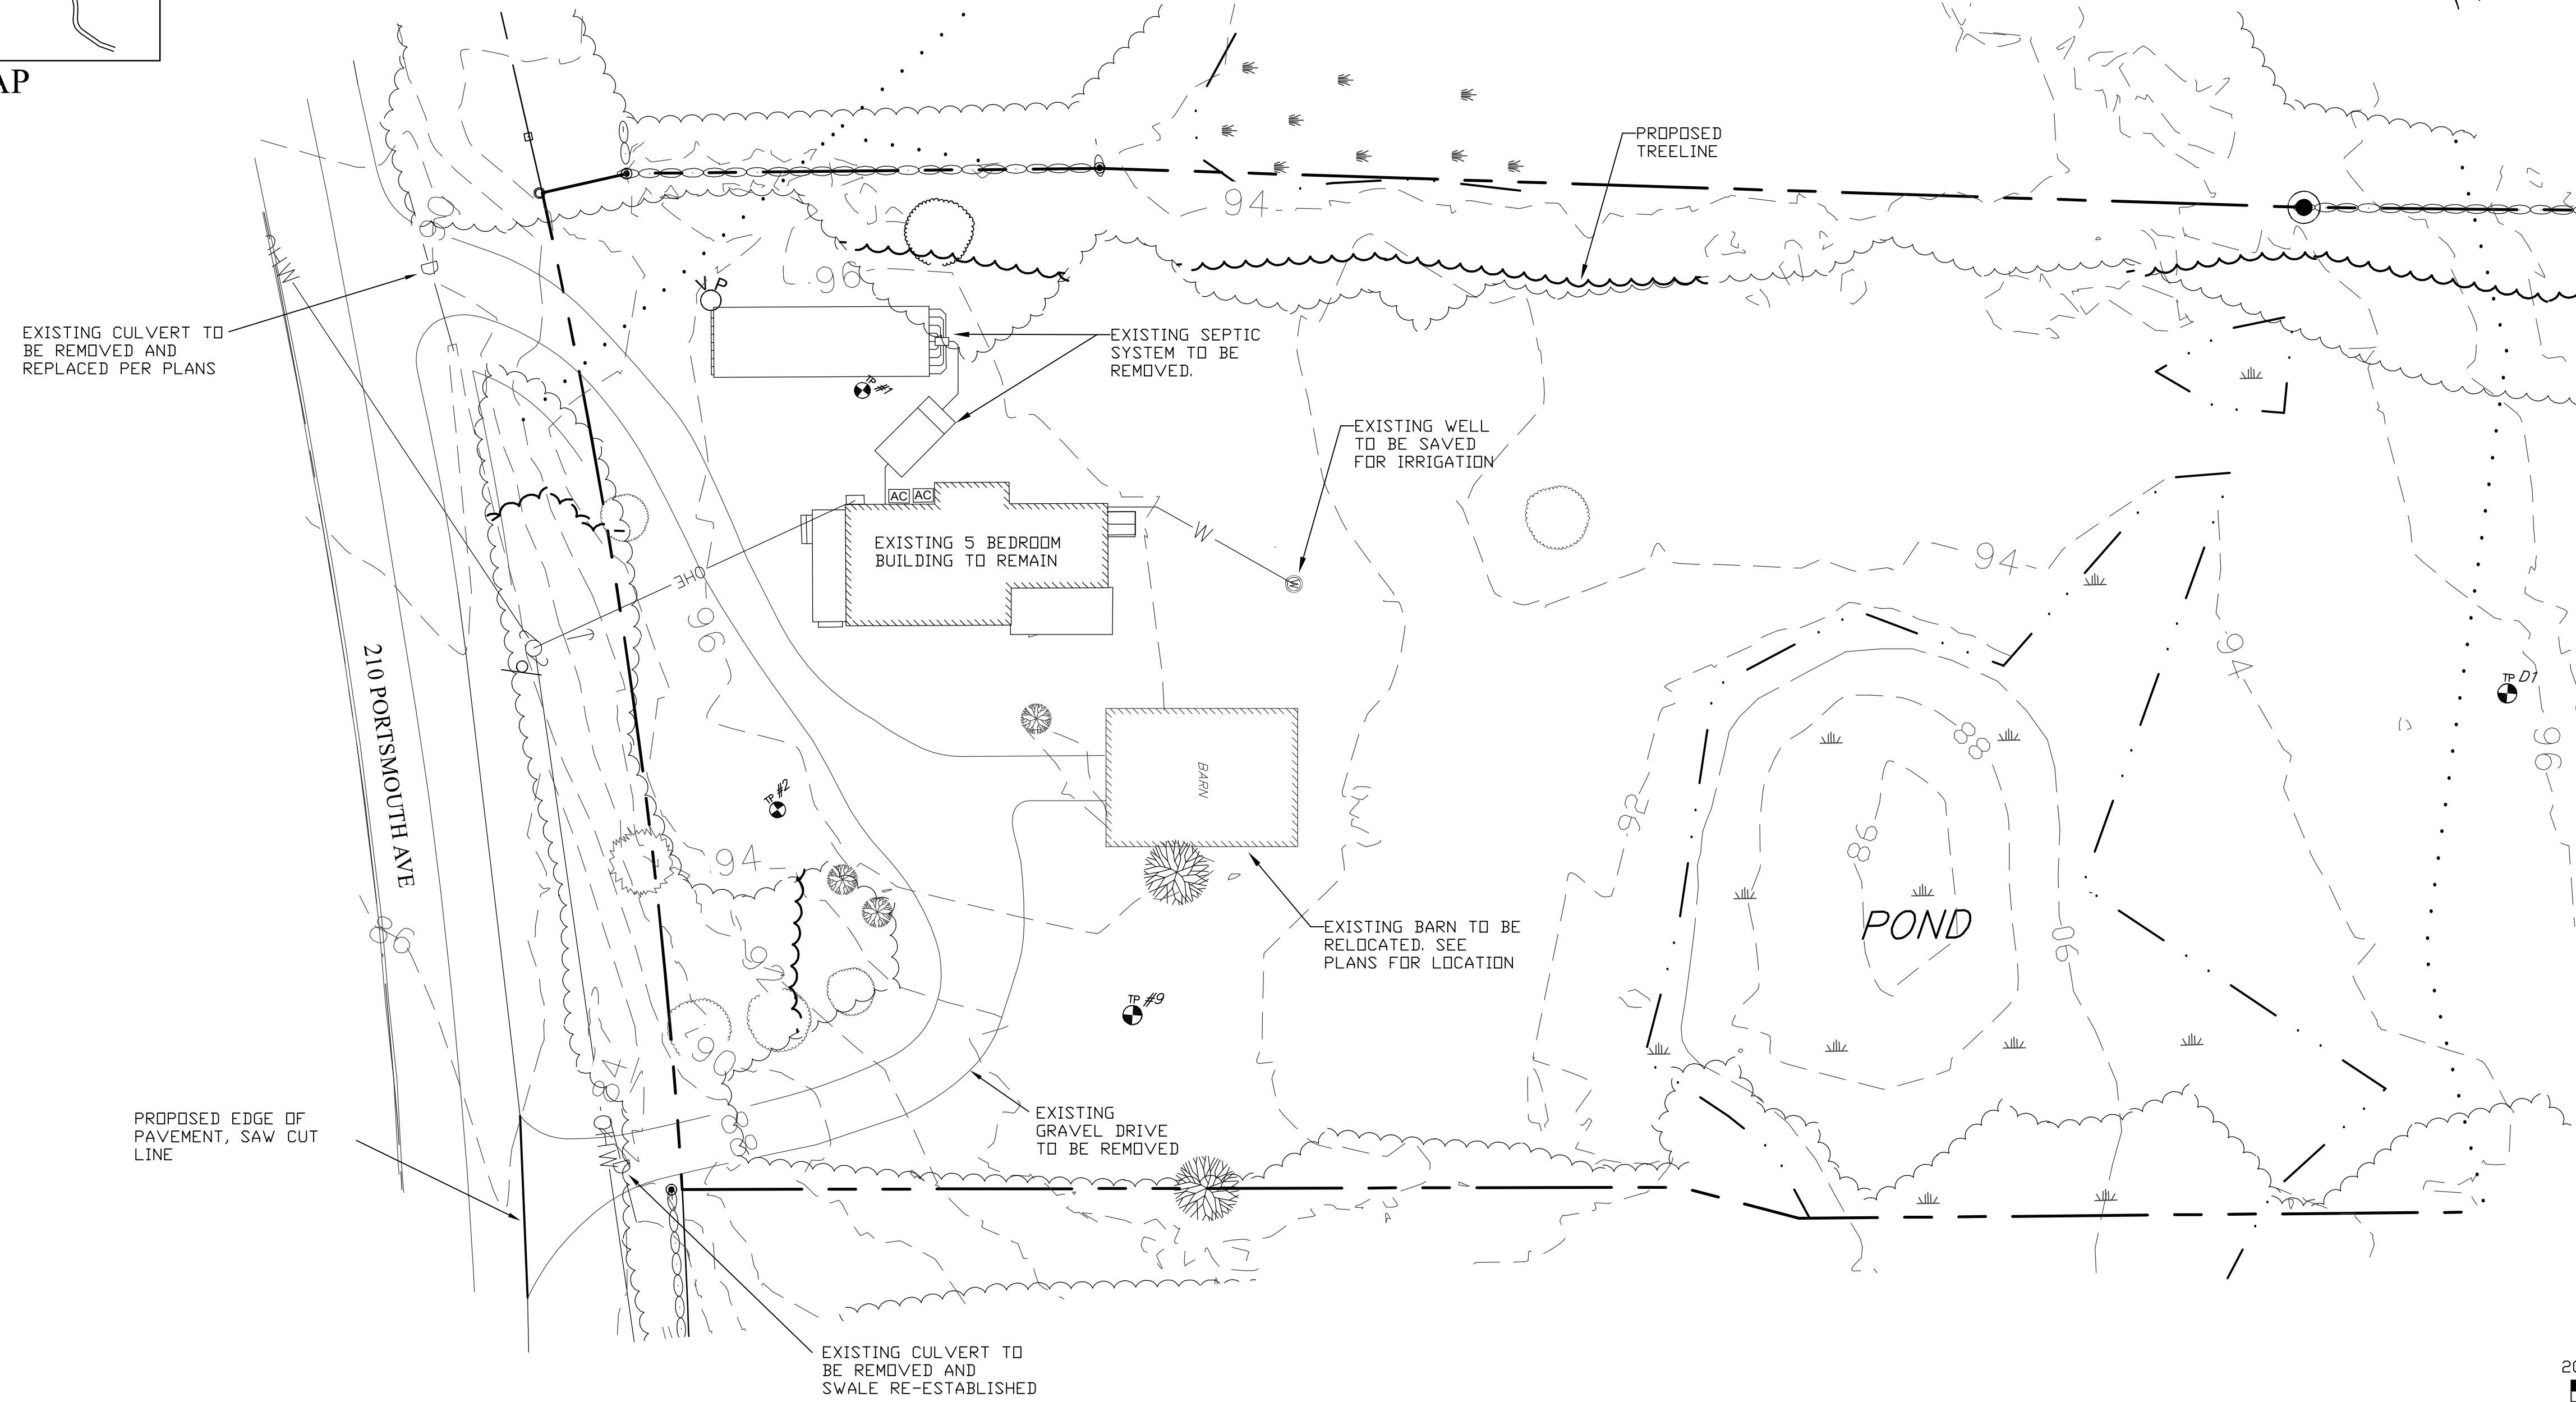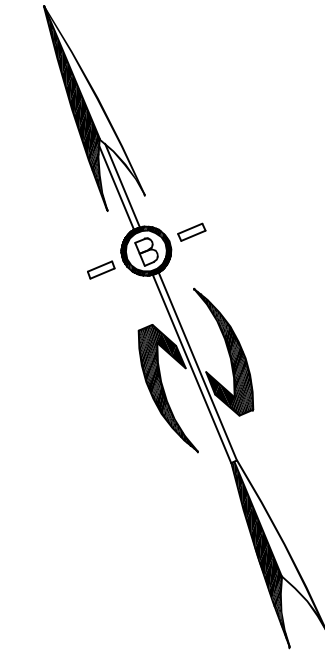

**DEMOLITION NOTES**

1. EROSION CONTROL MEASURES SHALL BE INSTALLED PRIOR TO THE START OF ANY CLEARING OR DEMOLITION ACTIVITIES.
2. THE LOCATIONS OF UNDERGROUND UTILITIES ARE APPROXIMATE AND THE LOCATIONS ARE NOT GUARANTEED BY THE OWNER OR THE ENGINEER. IT IS THE CONTRACTOR'S RESPONSIBILITY TO LOCATE ALL UTILITIES, ANTICIPATE CONFLICTS, REPAIR EXISTING UTILITIES AND RELOCATE EXISTING UTILITIES REQUIRED TO COMPLETE THE WORK.
3. THE CONTRACTOR SHALL VERIFY LOCATION OF ALL EXISTING UTILITIES. CALL DIG SAFE AT LEAST 72 HOURS PRIOR TO THE COMMENCEMENT OF ANY DEMOLITION/CONSTRUCTION ACTIVITIES.
4. ALL MATERIALS SCHEDULED TO BE REMOVED SHALL BECOME THE PROPERTY OF THE CONTRACTOR UNLESS OTHERWISE SPECIFIED. THE CONTRACTOR SHALL DISPOSE OF ALL MATERIALS OFF-SITE IN ACCORDANCE WITH ALL FEDERAL, STATE, AND LOCAL REGULATIONS, ORDINANCES AND CODES.
5. COORDINATE REMOVAL, RELOCATION, DISPOSAL OR SALVAGE OF UTILITIES WITH THE OWNER AND APPROPRIATE UTILITY COMPANY.
6. ANY EXISTING WORK OR PROPERTY DAMAGED OR DISRUPTED BY CONSTRUCTION/ DEMOLITION ACTIVITIES SHALL BE REPLACED OR REPAIRED TO MATCH ORIGINAL EXISTING CONDITIONS BY THE CONTRACTOR AT NO ADDITIONAL COST TO THE OWNER.
7. IT IS THE CONTRACTOR'S RESPONSIBILITY TO FAMILIARIZE THEMSELVES WITH THE CONDITIONS OF ALL OF THE PERMIT APPROVALS.
8. THE CONTRACTOR SHALL OBTAIN AND PAY FOR ADDITIONAL PERMITS, NOTICES AND FEES NECESSARY TO COMPLETE THE WORK AND ARRANGE FOR AND PAY FOR NECESSARY INSPECTIONS AND APPROVALS FROM THE AUTHORITIES HAVING JURISDICTION.
9. THE CONTRACTOR SHALL BE RESPONSIBLE FOR ALL DEMOLITION AND OFF-SITE DISPOSAL OF MATERIALS REQUIRED TO COMPLETE THE WORK.
10. REMOVE TREES AND BRUSH AS REQUIRED FOR COMPLETION OF WORK; CONTRACTOR SHALL GRUB AND REMOVE ALL STUMPS WITHIN LIMITS OF WORK AND DISPOSE OF OFF SITE IN ACCORDANCE WITH FEDERAL, STATE, AND LOCAL LAWS AND REGULATIONS.
11. CONTRACTOR SHALL PROTECT ALL PROPERTY MONUMENTATION THROUGHOUT DEMOLITION AND CONSTRUCTION OPERATIONS. SHOULD ANY MONUMENTATION BE DISTURBED BY THE CONTRACTOR, THE CONTRACTOR SHALL EMPLOY A NEW HAMPSHIRE LICENSED SURVEYOR TO REPLACE DISTURBED MONUMENTS.
12. THE CONTRACTOR SHALL PAY ALL COSTS NECESSARY FOR TEMPORARY PARTITIONING, BARRICADING, FENCING, SECURITY AND SAFETY DEVICES REQUIRED FOR THE MAINTENANCE OF A CLEAN AND SAFE CONSTRUCTION SITE.
13. SAW CUT AND REMOVE PAVEMENT AND CONSTRUCT PAVEMENT TRENCH PATCH FOR ALL UTILITIES TO BE REMOVED AND PROPOSED UTILITIES LOCATED IN EXISTING PAVEMENT AREAS TO REMAIN.



UNDERGROUND FACILITIES, UTILITIES,  
1-888-DIG-SAFE (1-888-344-7233).

REVISED PER REVIEW COMMENTS	05/05/26
REVISIONS:	DATE:
<b>DEMOLITION PLAN</b>	
PLAN FOR: RESIDENTIAL DEVELOPMENT 210 PORTSMOUTH AVE STRATHAM, NH	
DATE:	MAR 11, 2026
SCALE:	1"=20'
PROJ. NO:	NH-1566
SHEET NO.	2

**ZONING REQUIREMENTS**

ZONE: ROUTE 33 LEGACY HIGHWAY HERITAGE DISTRICT  
 FRONT YARD SETBACK: 35 FEET  
 SIDE YARD SETBACK: 20 FEET  
 REAR YARD SETBACK: 20 FEET  
 BUILDING HEIGHT: 35 FEET  
 WETLAND BUFFER: 0-25 FEET NO DISTURBANCE  
 25-75 FEET WETLAND SETBACK  
 75 FEET SEPTIC

**NOTES:**

- SUBJECT PARCEL: TAX MAP 21 LOT 81  
210 PORTSMOUTH AVE  
STRATHAM, NH
- OWNER OF RECORD: RED BARN PROPERTY LLC  
6 SHORE DRIVE  
GREENLAND, NH 03840  
R.C.R.D. BOOK 6543, PAGE 1271
- PARCEL AREA: 484,172 S.F. OR 11.12 AC
- ZONE: ROUTE 33 LEGACY HIGHWAY HERITAGE  
OVERLAY DISTRICTS: WETLANDS CONSERVATION DISTRICT
- WETLAND DELINEATION CONDUCTED BY SERGIO BONILLA, NEW HAMPSHIRE STATE CERTIFIED WETLAND SCIENTIST (#261) ON 1/14/2025 IN ACCORDANCE WITH THE UNITED STATES ARMY CORPS OF ENGINEERS WETLANDS DELINEATION MANUAL, TECHNICAL REPORT Y-87-1 (JANUARY 1987), AND THE REGIONAL SUPPLEMENT TO THE CORPS OF ENGINEERS WETLAND DELINEATION MANUAL: NORTHCENTRAL AND NORTHEAST REGION (VERSION 2-TR-12-1, JANUARY 2012).

**SUMMARY OF PROPOSED RESIDENTIAL DUPLEXES**


EACH PROPOSED DUPLEX IS 2-STORIES WITH SIDE-BY-SIDE UNITS.  
 EXISTING DUPLEX: 1 3BR & 1 2BR UNIT  
 PROPOSED DUPLEX #1: 1 1BR & 1 2BR UNIT  
 PROPOSED DUPLEX #2: 2 2BR UNITS  
 PROPOSED DUPLEX #3: 2 2BR UNITS  
 PROPOSED DUPLEX #4: 2 2BR UNITS

PREPARED FOR:


RED BARN PROPERTY LLC  
 6 SHORE DRIVE  
 GREENLAND, NH 03840



70 PORTSMOUTH AVE,  
 THIRD FLOOR, SUITE 2  
 STRATHAM, N.H. 03885  
 PHONE: 603-583-4860.

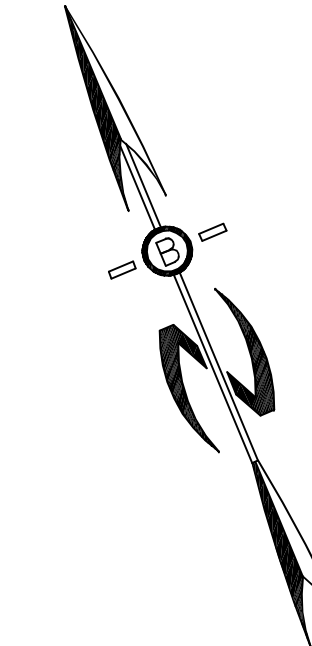




THE PURPOSE OF THE PROJECT IS TO CONSTRUCT 4 NEW DUPLEXES IN A CONDOMINIUM OWNERSHIP.

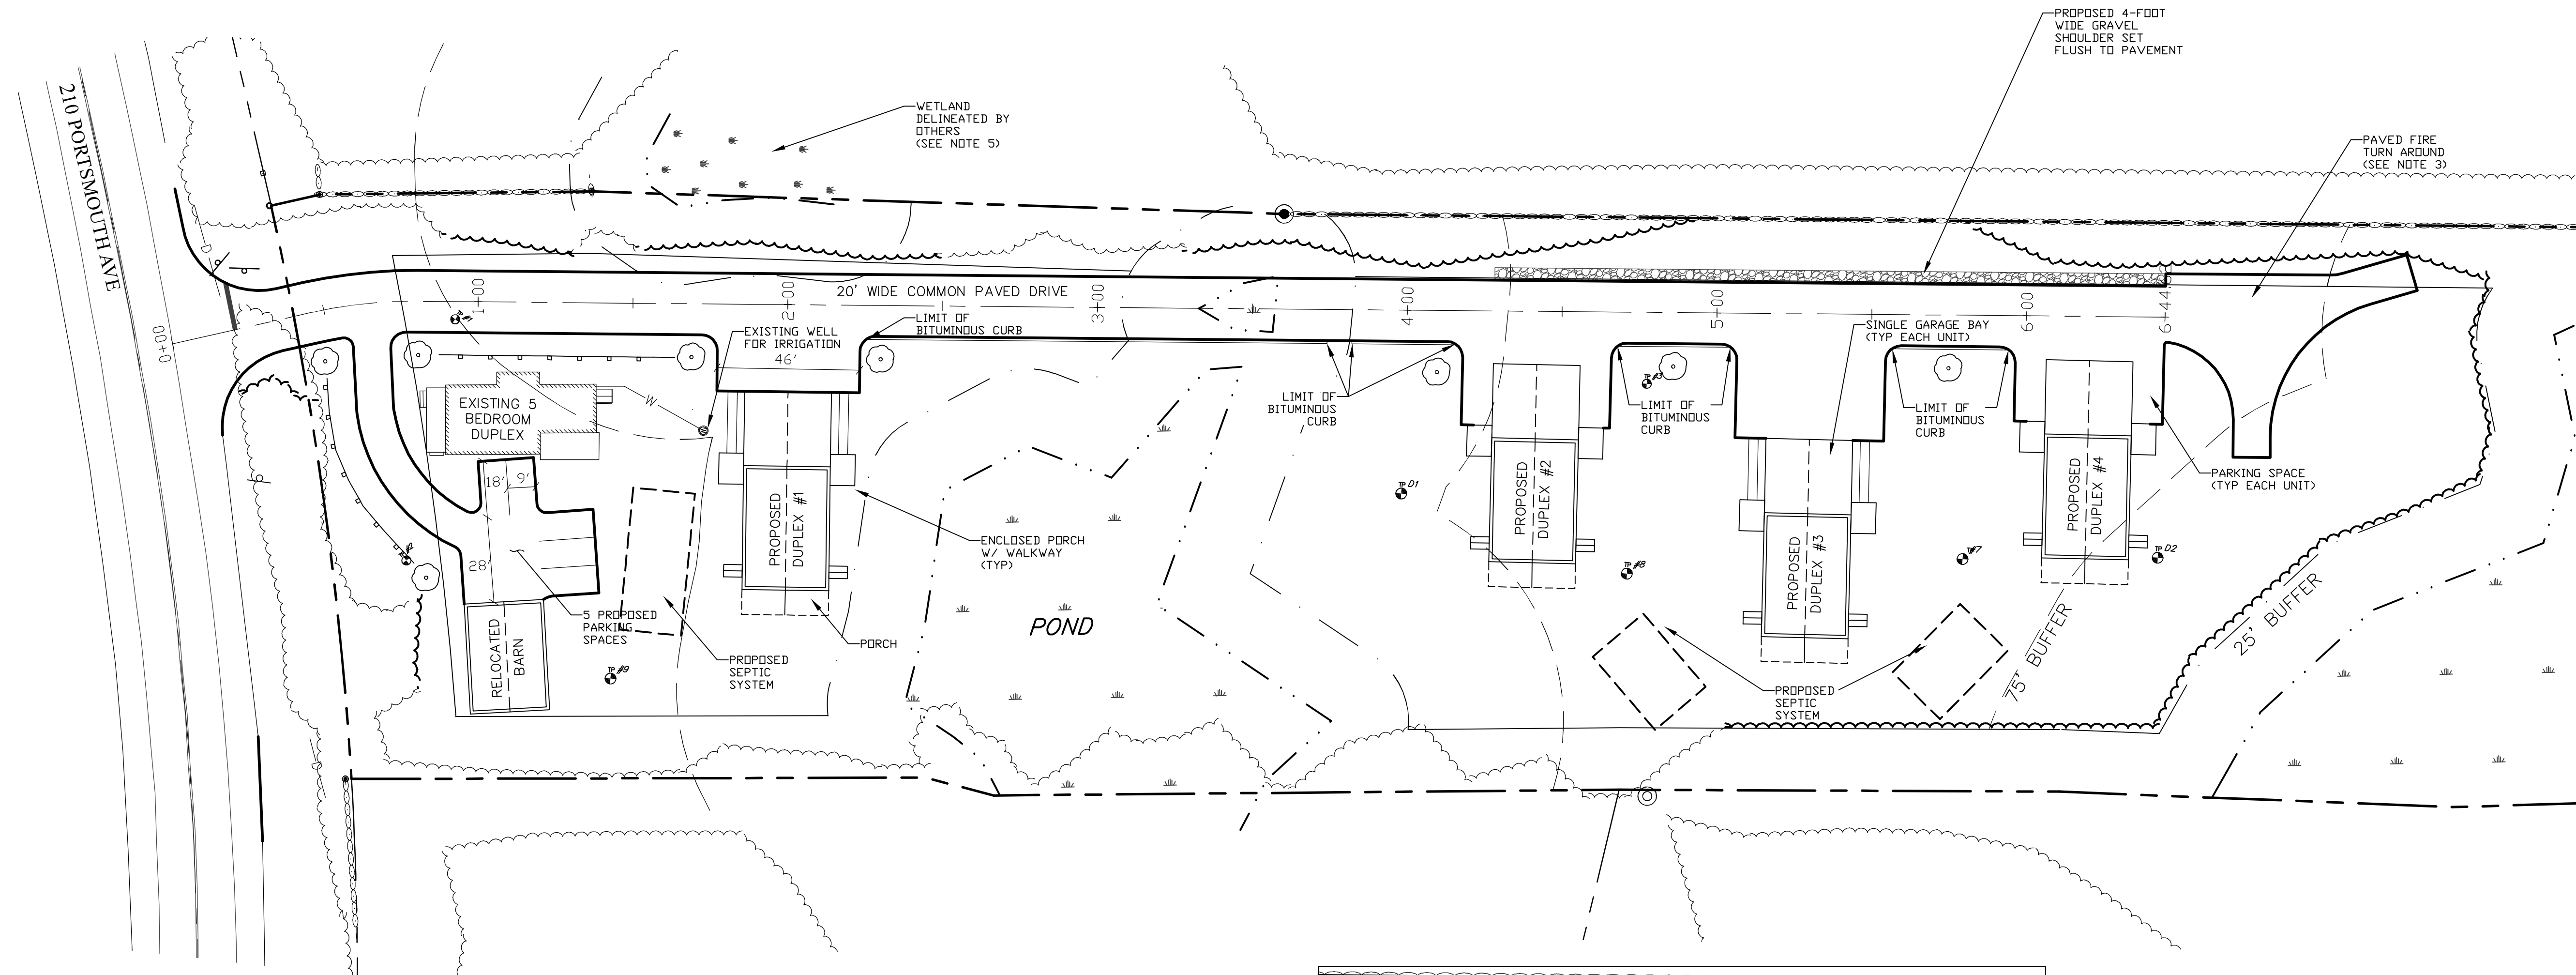

**SITE NOTES**


- ALL MATERIALS AND CONSTRUCTION SHALL CONFORM WITH APPLICABLE FEDERAL, STATE, AND LOCAL CODES & SPECIFICATIONS. COORDINATE ALL WORK WITHIN PUBLIC RIGHT OF WAY WITH THE TOWN OF STRATHAM.
- ALL WORK SHALL CONFORM TO THE TOWN OF STRATHAM DEPARTMENT OF PUBLIC WORKS, STANDARD SPECIFICATIONS AND WITH THE STATE OF NEW HAMPSHIRE DEPARTMENT OF TRANSPORTATION, "STANDARD SPECIFICATIONS OF ROAD AND BRIDGE CONSTRUCTION", CURRENT EDITION.
- FIRE TRUCK TURNAROUND AREA SHALL BE KEPT CLEAR OF SNOW, VEHICLES, AND ANY OTHER OBSTACLES.
- LANDSCAPING AND FENCING LOCATIONS SHOWN MAY VARY AND WILL BE FINALIZED AFTER UNITS ARE CONSTRUCTED.

**LEGEND:**

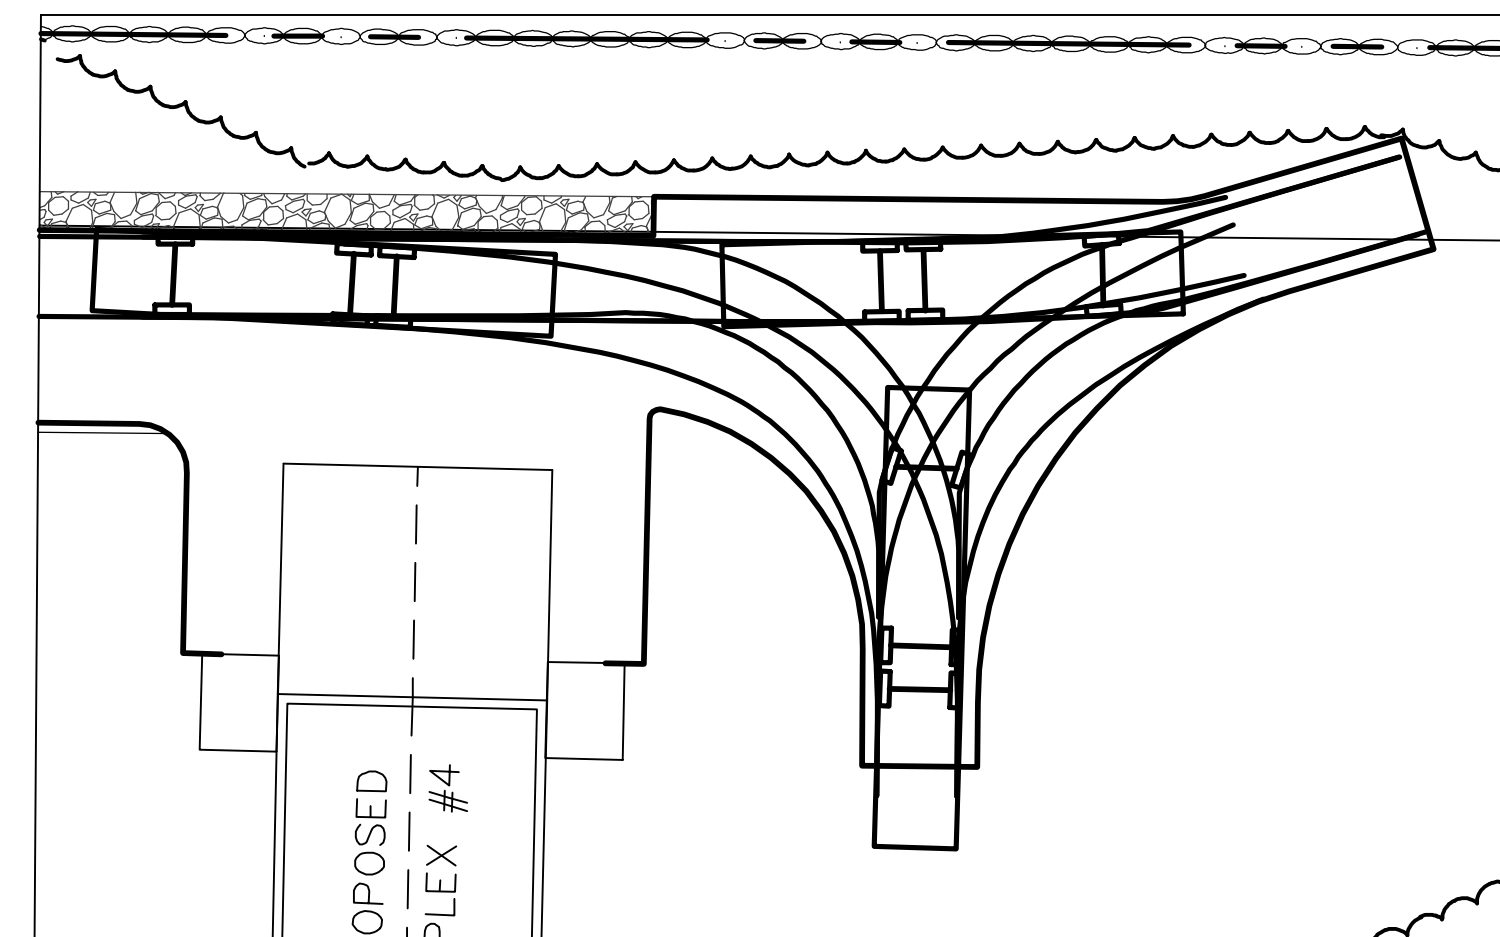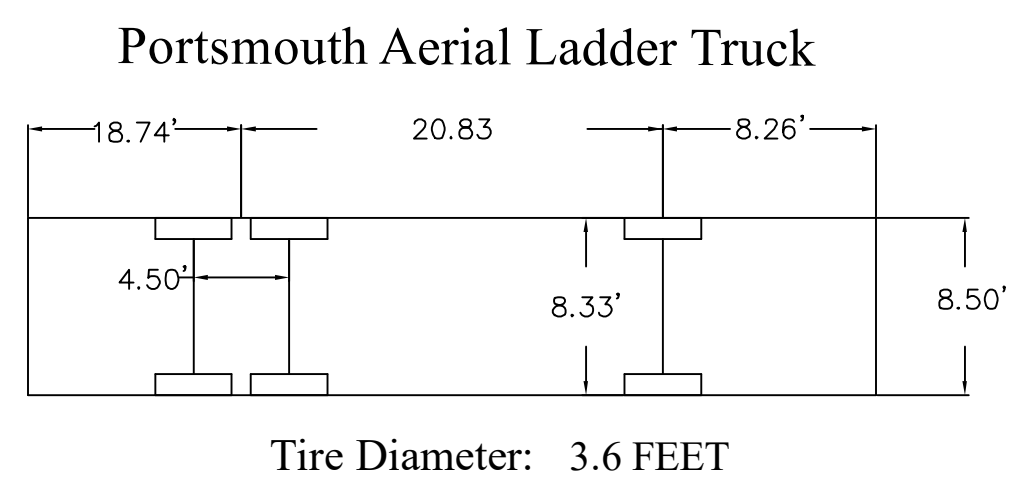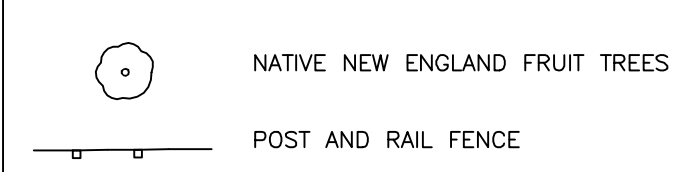

FIRE TRUCK MANEUVERING INSET

SCALE: 1" = 20'

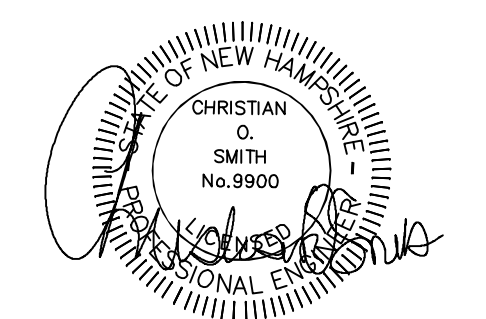

REVISED PER REVIEW COMMENTS	05/05/26
REVISIONS:	DATE:
<b>SUBDIVISION PLAN</b>	
PLAN FOR: RESIDENTIAL DEVELOPMENT 210 PORTSMOUTH AVE STRATHAM, NH	
DATE: MAR 11, 2026	SCALE: 1"=30'
PROJ. NO: NH-1566	SHEET NO. 3

**GRADING AND DRAINAGE NOTES**

1. COMPACTION REQUIREMENTS:  
 BELOW PAVED OR CONCRETE AREAS 95%  
 TRENCH BEDDING MATERIAL AND SAND BLANKET BACKFILL 95%  
 BELOW LOAM AND SEED AREAS 90%  
 \* ALL PERCENTAGES OF COMPACTION SHALL BE OF THE MAXIMUM DRY DENSITY AT THE OPTIMUM MOISTURE CONTENT AS DETERMINED AND CONTROLLED IN ACCORDANCE WITH ASTM D-1557, METHOD C FIELD DENSITY TESTS SHALL BE MADE IN ACCORDANCE WITH ASTM D-1556 OR ASTM-2922.
2. CONTRACTOR SHALL PROVIDE A FINISH PAVEMENT SURFACE AND LAWN AREAS FREE OF LOW SPOTS AND PONDING AREAS.
3. ALL MATERIALS AND CONSTRUCTION SHALL CONFORM WITH APPLICABLE FEDERAL, STATE AND LOCAL CODES.
4. ALL DISTURBED AREAS NOT TO BE PAVED OR OTHERWISE TREATED SHALL RECEIVE 4" LOAM, SEED FERTILIZER AND MULCH.
5. ALL WORK SHALL CONFORM TO THE TOWN OF STRATHAM DEPARTMENT OF PUBLIC WORKS, STANDARD SPECIFICATIONS AND WITH THE STATE OF NEW HAMPSHIRE DEPARTMENT OF TRANSPORTATION, "STANDARD SPECIFICATIONS OF ROAD AND BRIDGE CONSTRUCTION", CURRENT EDITION.
6. APPROXIMATE DISTURBANCE = 85,000 SF.

**EROSION CONTROL NOTES**



1. INSTALL EROSION CONTROL BARRIERS AS SHOWN AS FIRST ORDER OF WORK.
2. SEE GENERAL EROSION CONTROL NOTES ON "EROSION CONTROL NOTES & DETAILS SHEET".
3. INSTALL STABILIZED CONSTRUCTION EXIT.
4. INSPECT INLET PROTECTION AND PERIMETER EROSION CONTROL MEASURES DAILY AND AFTER EACH RAIN STORM OF 0.25 INCH OR GREATER. REPAIR/MODIFY PROTECTION AS NECESSARY TO MAXIMIZE EFFICIENCY OF FILTER. REPLACE ALL FILTERS WHEN SEDIMENT IS 1/3 THE FILTER HEIGHT.
5. CONSTRUCT EROSION CONTROL BLANKET ON ALL SLOPES STEEPER THAN 3:1.
6. PRIOR TO ANY WORK OR SOIL DISTURBANCE COMMENCING ON THE SUBJECT PROPERTY, INCLUDING MOVING OF EARTH, THE APPLICANT SHALL INSTALL ALL EROSION AND SILTATION MITIGATION AND CONTROL MEASURES AS REQUIRED BY STATE AND LOCAL PERMITS AND APPROVALS.
7. CONTRACTOR SHALL BE RESPONSIBLE TO CONTROL DUST AND WIND EROSION THROUGHOUT THE CONSTRUCTION PERIOD. DUST CONTROL MEASURES SHALL INCLUDE, BUT ARE NOT LIMITED TO, SPRINKLING WATER ON UNSTABLE SOILS SUBJECT TO ARID CONDITIONS.
8. THE CONTRACTOR SHALL REMOVE AND PROPERLY DISPOSE OF ALL TEMPORARY EROSION CONTROL DEVICES UPON COMPLETION OF CONSTRUCTION.
9. TEMPORARY SOIL STOCKPILE SHALL BE SURROUNDED WITH PERIMETER CONTROLS AND SHALL BE STABILIZED BY TEMPORARY EROSION CONTROL SEEDING. STOCKPILE AREAS TO BE LOCATED AS FAR AS POSSIBLE FROM THE DELINEATED EDGE OF WETLANDS.
10. SAFETY FENCING SHALL BE PROVIDED AROUND STOCKPILES OVER 10 FT.

PREPARED FOR:

RED BARN PROPERTY LLC  
 6 SHORE DRIVE  
 GREENLAND, NH 03840



70 PORTSMOUTH AVE,  
 THIRD FLOOR, SUITE 2  
 STRATHAM, N.H. 03885  
 PHONE: 603-583-4860.

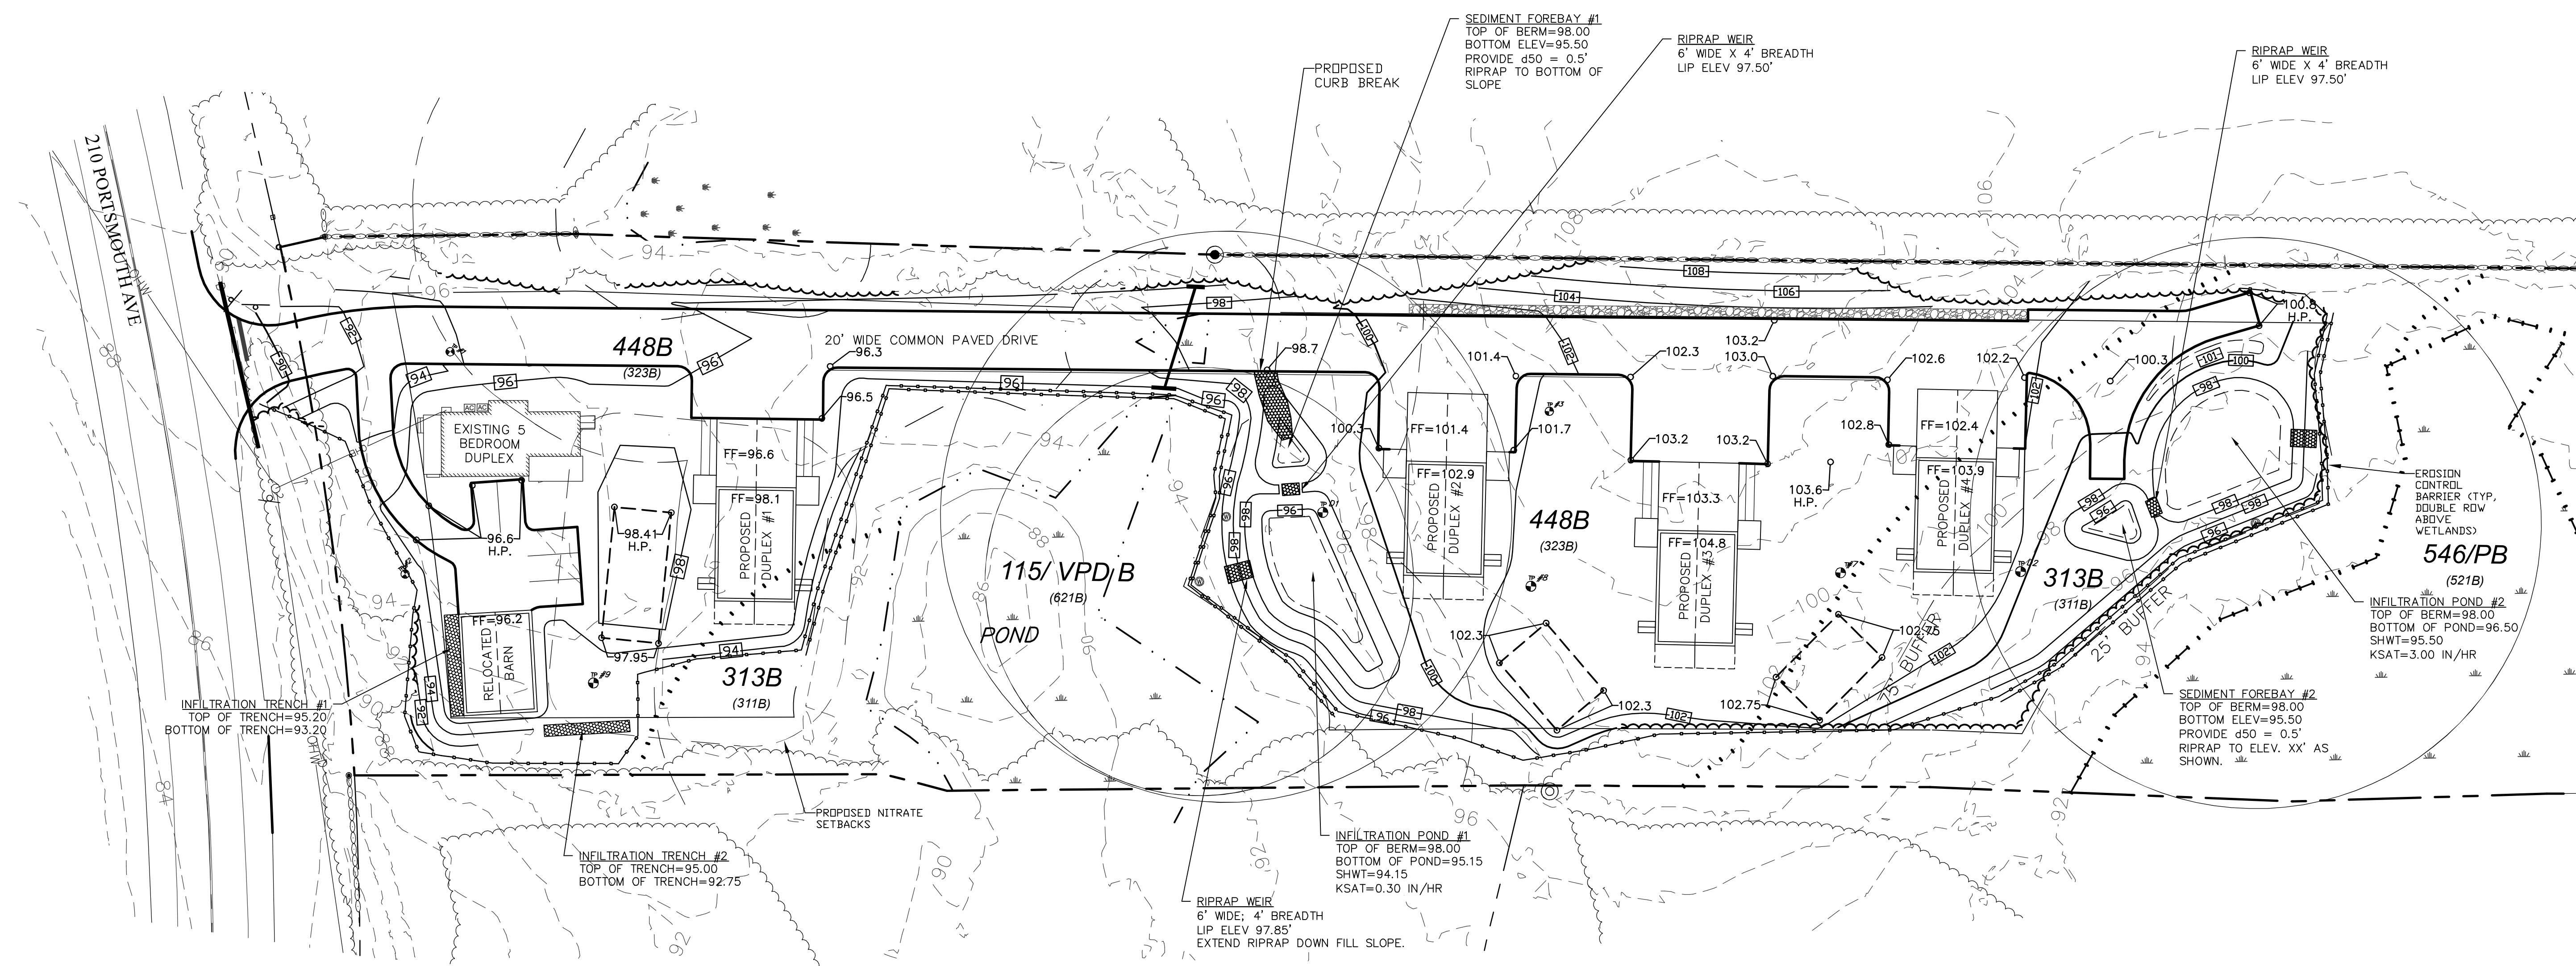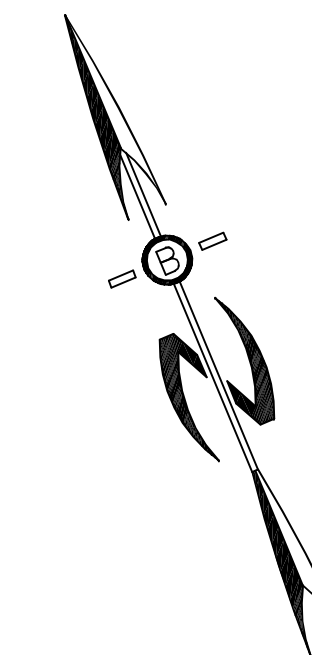

**SOIL NOTES**

THE SITE SPECIFIC SOIL SURVEY (SSSS) WAS PRODUCED 11/24/25, AND WAS PREPARED BY LUKE HURLEY, CSS # 095, HURLEY ENVIRONMENTAL AND LAND PLANNING, LLC.

SOILS WERE IDENTIFIED WITH THE NEW HAMPSHIRE STATE-WIDE NUMERICAL SOILS LEGEND, USDA NRCS, DURHAM, NH. ISSUE #10, JANUARY 2011. THE NUMERIC LEGEND WAS AMENDED TO IDENTIFY THE CORRECT SOILS COMPONENTS OF THE COMPLEX.

HYDROLOGIC SOIL GROUP FROM KSAT VALUES FOR NEW HAMPSHIRE SOILS, SOCIETY OF SOIL SCIENTISTS OF NEW ENGLAND, SPECIAL PUBLICATION NO. 5, SEPTEMBER, 2009.

SSSM SYMBOL	SSS MAP NAME	HISS SYMBOL	HYDROLOGIC SOIL GROUP
313	DEERFIELD	311	B
448	SCITUATE	323	C
546	WALPOLE	521	C
115	SCARBORO	621	D

SLOPE PHASE:  
 0-8% B 8-15% C 15-25% D 25%+ E

313 B (311B) ← SITE SPECIFIC SOIL MAPPING (SSSM) SYMBOL  
 ← HIGH INTENSITY SOIL SURVEY (HISS) SYMBOL



UNDERGROUND FACILITIES, UTILITIES.  
 1-888-DIG-SAFE (1-888-344-7233).




REVISED PER REVIEW COMMENTS	05/05/26
REVISIONS:	DATE:

**GRADING, DRAINAGE, & EROSION CONTROL PLAN**

PLAN FOR:  
 RESIDENTIAL DEVELOPMENT  
 210 PORTSMOUTH AVE  
 STRATHAM, NH

DATE:	MAR 11, 2026	SCALE:	1"=30'
PROJ. NO.:	NH-1566	SHEET NO.:	4

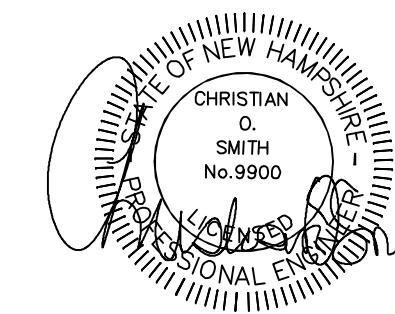




PREPARED FOR:  
**RED BARN PROPERTY LLC**  
 6 SHORE DRIVE  
 GREENLAND, NH 03840

**BA**  
**BEALS**  
 ASSOCIATES, PLLC

70 PORTSMOUTH AVE,  
 THIRD FLOOR, SUITE 2  
 STRATHAM, N.H. 03885  
 PHONE: 603-583-4860.

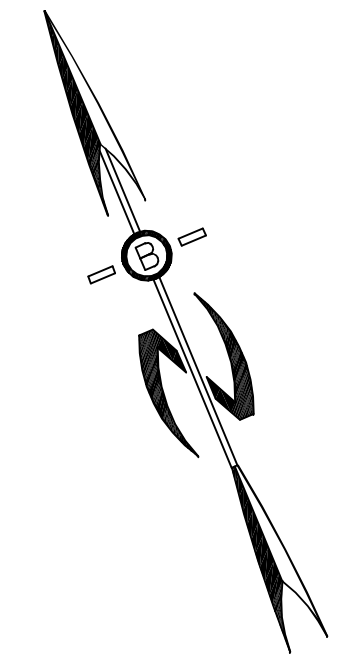

REVISED PER REVIEW COMMENTS	05/05/26
REVISIONS:	DATE:


**AERIAL OVERLAY PLAN**

PLAN FOR:  
 RESIDENTIAL DEVELOPMENT  
 210 PORTSMOUTH AVE  
 STRATHAM, NH

DATE:	MAR 11, 2026	SCALE:	1"=100'
PROJ. NO:	NH-1566	SHEET NO.	5

LEGEND



- DIRECT WETLAND IMPACT  
287 SF
- 0-25' WETLAND BUFFER IMPACT  
3,659 SF
- 25-75' WETLAND BUFFER IMPACT  
31,262 SF

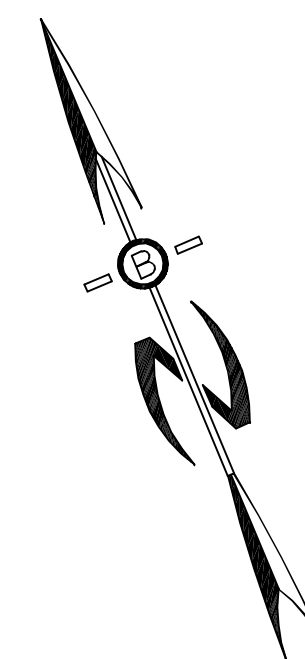

PREPARED FOR:  
**RED BARN PROPERTY LLC**  
 6 SHORE DRIVE  
 GREENLAND, NH 03840



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 STRATHAM, N.H. 03885  
 PHONE: 603-583-4860.

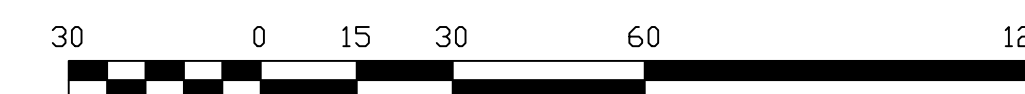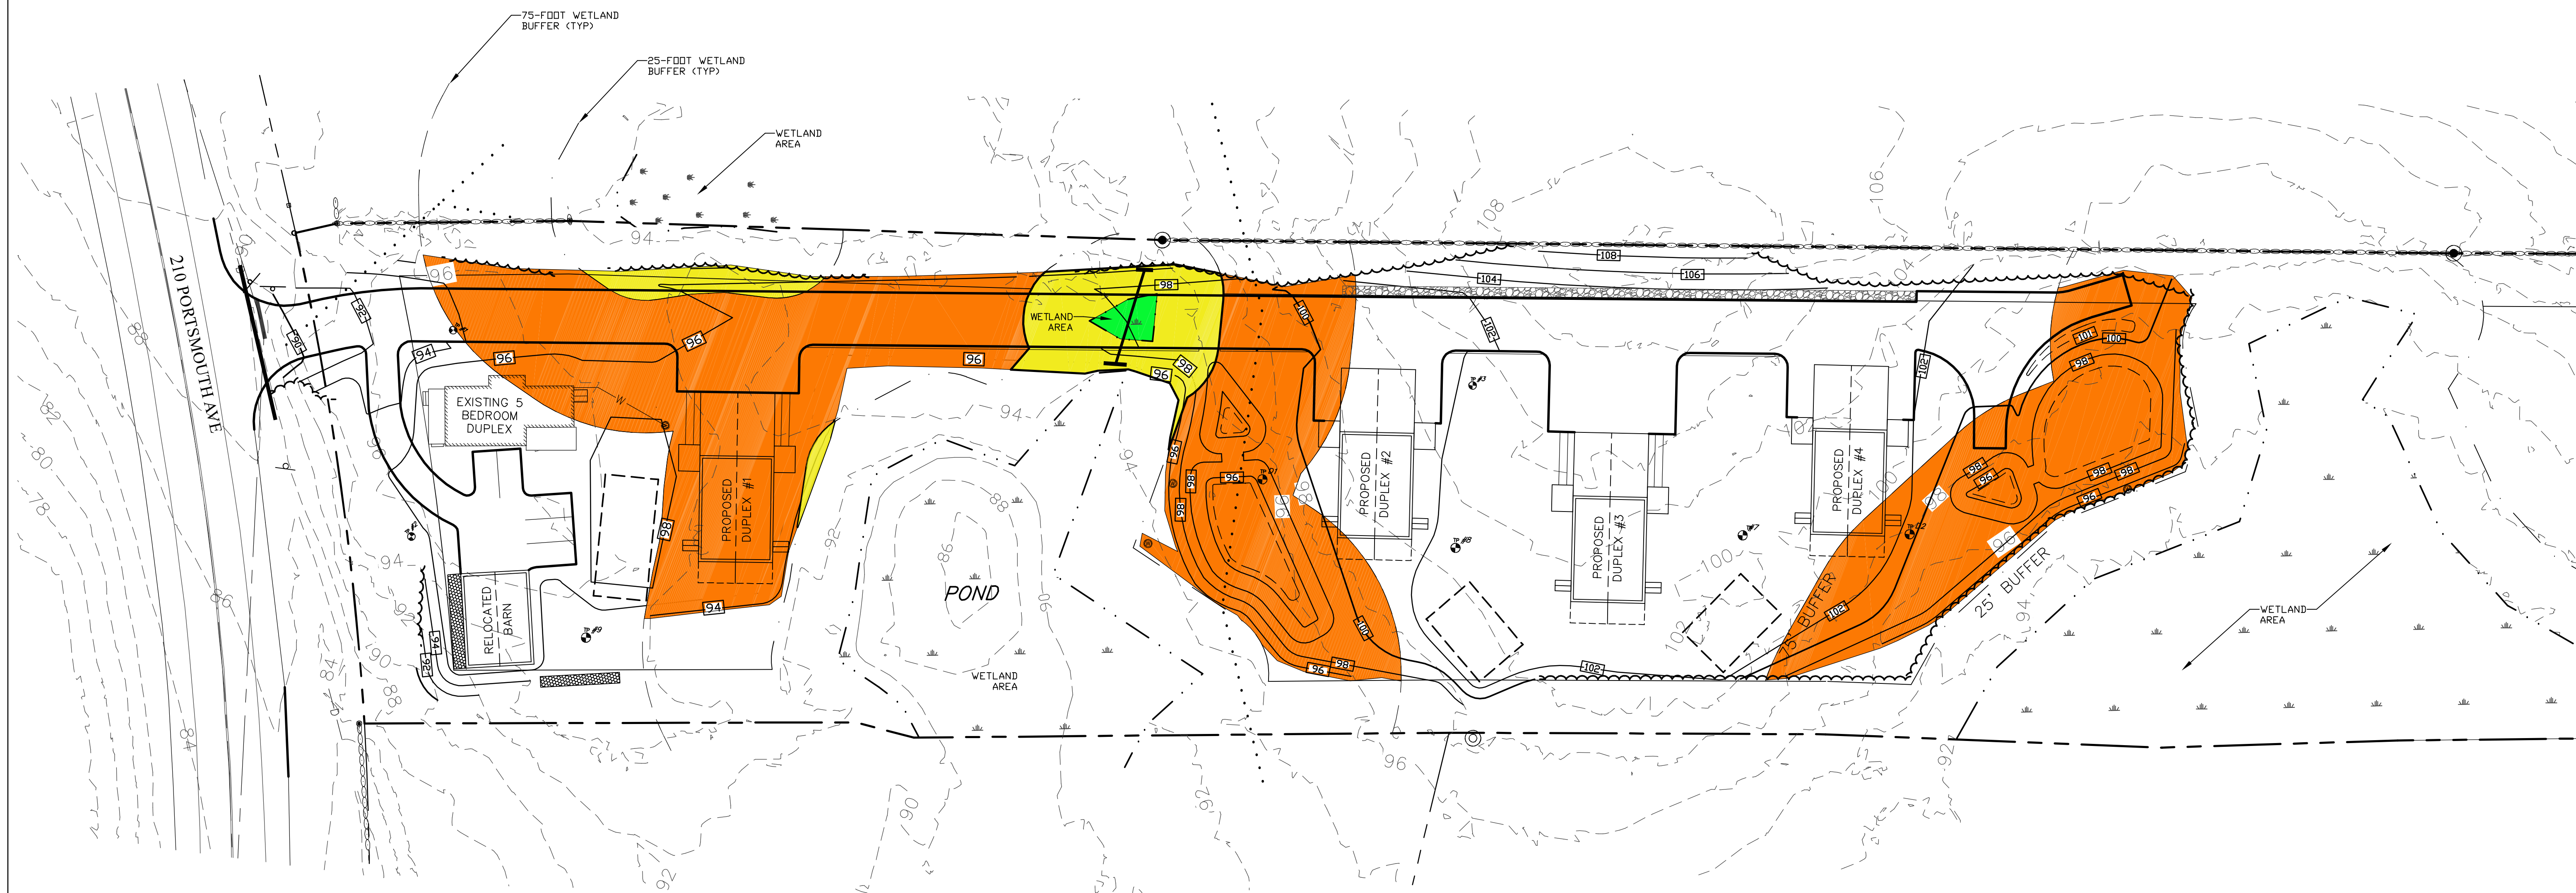

REVISED PER REVIEW COMMENTS	05/05/26
REVISIONS:	DATE:

**WETLAND IMPACT PLAN**



PLAN FOR:  
 RESIDENTIAL DEVELOPMENT  
 210 PORTSMOUTH AVE  
 STRATHAM, NH

DATE:	MAR 11, 2026	SCALE:	1"=30'
PROJ. NO.:	NH-1566	SHEET NO.:	6

PREPARED FOR:  
**RED BARN PROPERTY LLC**  
 6 SHORE DRIVE  
 GREENLAND, NH 03840



70 PORTSMOUTH AVE,  
 THIRD FLOOR, SUITE 2  
 STRATHAM, N.H. 03885  
 PHONE: 603-583-4860,

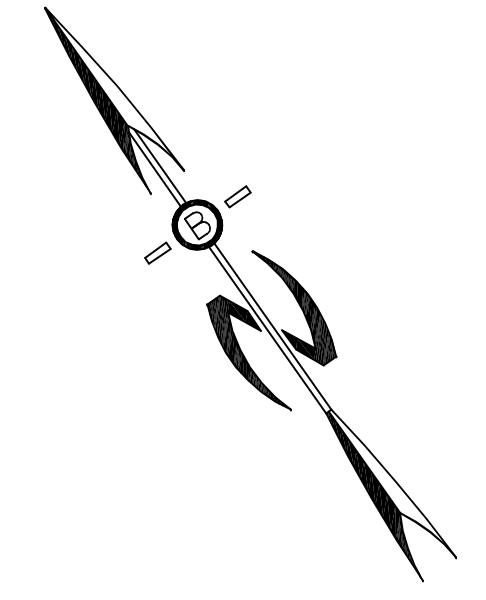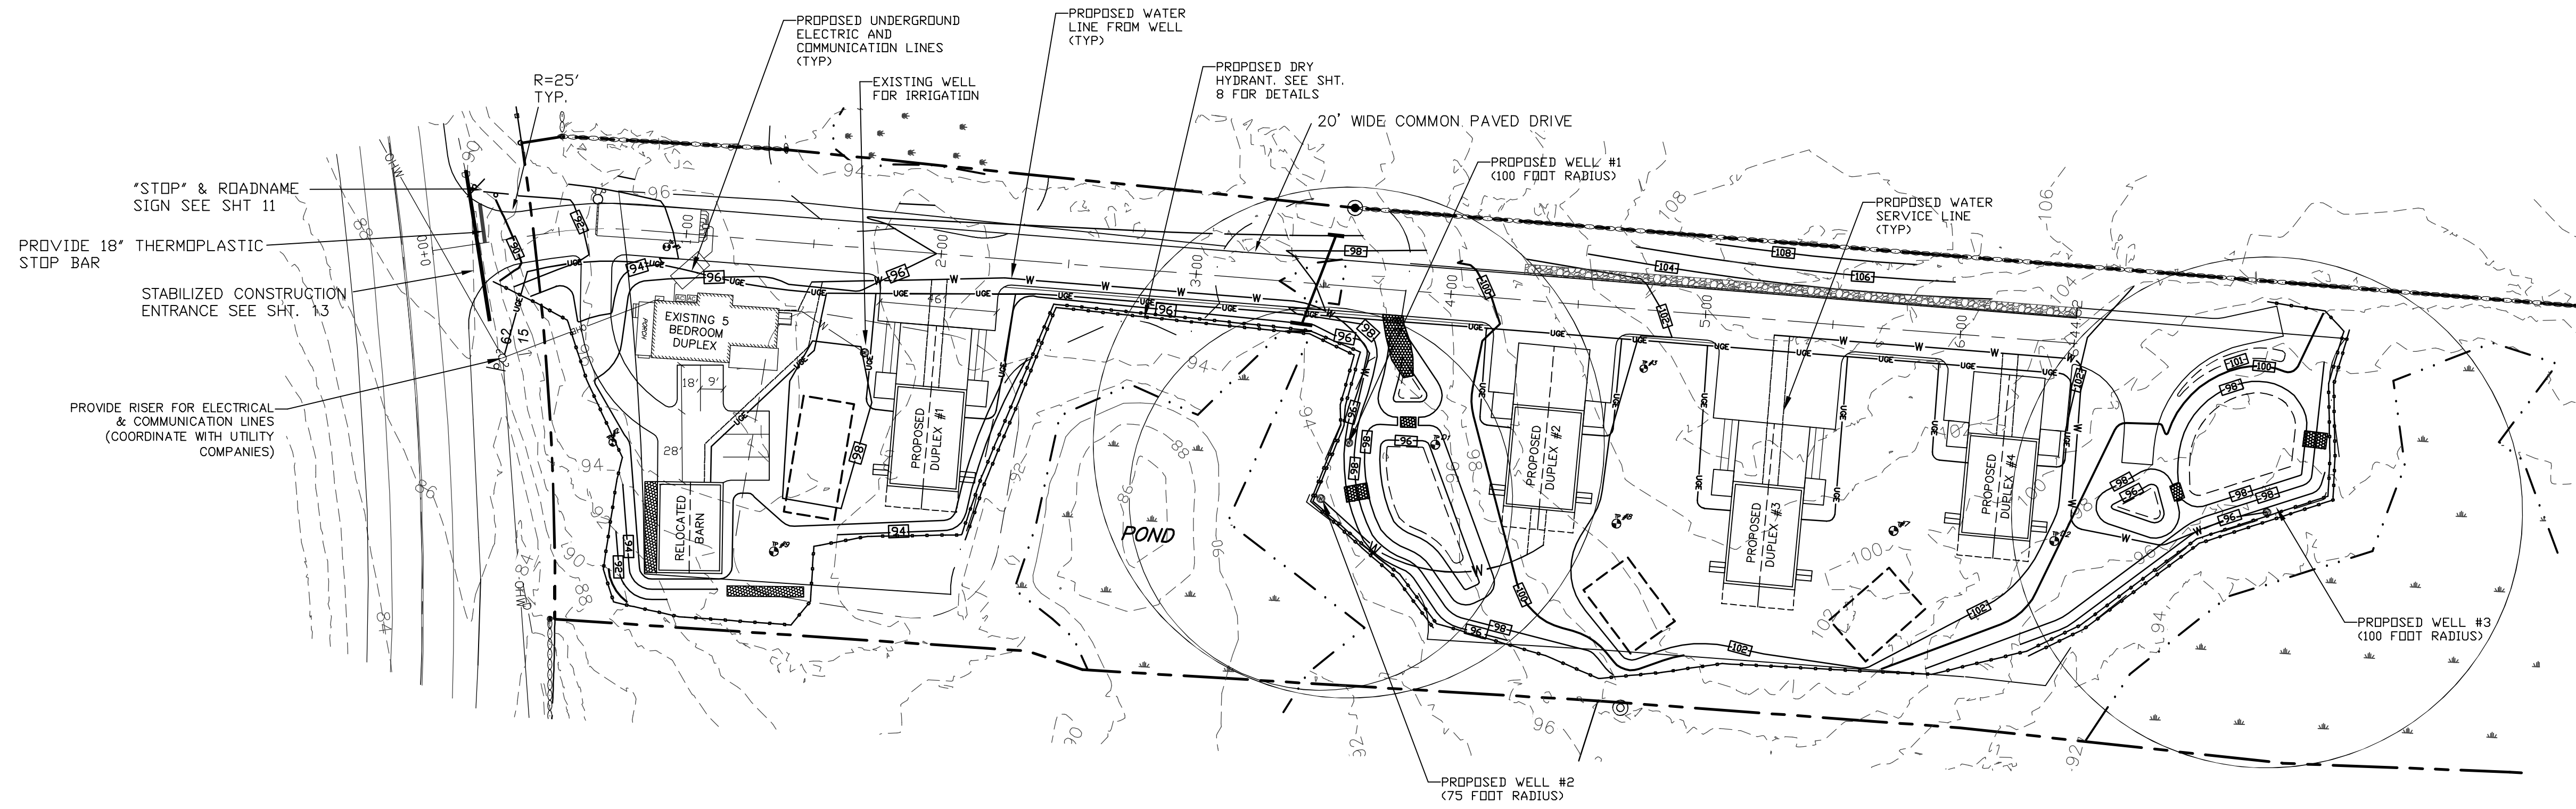

**SEPTIC & WELL CALCULATIONS**

**REQUIRED FLOW:**  
 300 GPD FOR EACH 2BR UNIT + 150 GPD FOR EACH ADDITION BR  
 225 GPD FOR EACH 1 BR UNIT

EXISTING 5 BR DUPLEX = 300 + 450 = 750 GPD  
 PROPOSED 2-2 BR DUPLEX = 300 + 300 = 600 GPD  
 PROPOSED 1-1 BR & 1-2 BR DUPLEX = 225 + 300 = 525 GPD


**FRONT AREA:**  
 - EXISTING 5BR DUPLEX: 5 PEOPLE & 750 GPD  
 - PROPOSED 3BR DUPLEX #1: 3.5 PEOPLE & 525 GPD  
 - BARN: 0 PEOPLE & 0 GPD  
 - TOTAL: 8.5 PEOPLE & 1,275 GPD

**BACK AREA:**  
 - PROPOSED 4BR DUPLEX #2: 5 PEOPLE & 600 GPD  
 - PROPOSED 4BR DUPLEX #3: 5 PEOPLE & 600 GPD  
 - PROPOSED 4BR DUPLEX #4: 5 PEOPLE & 600 GPD  
 - TOTAL: 15 PEOPLE & 1,800 GPD

**SUMMARY TOTAL** 23.5 PEOPLE & 3,075 GPD


EXISTING DUPLEX (5BR) & PROPOSED DUPLEX #1 (3BR) PROPOSED WELL #1 = 1,275 GPD  
 PROPOSED DUPLEX #2 (4BR) PROPOSED WELL #2 = 600 GPD  
 PROPOSED DUPLEX #3 & #4 (8BR) PROPOSED WELL #3 = 1,200 GPD

**WELL RADI:**  
 0- 750 GPD 75'  
 751-1,440 GPD 100'

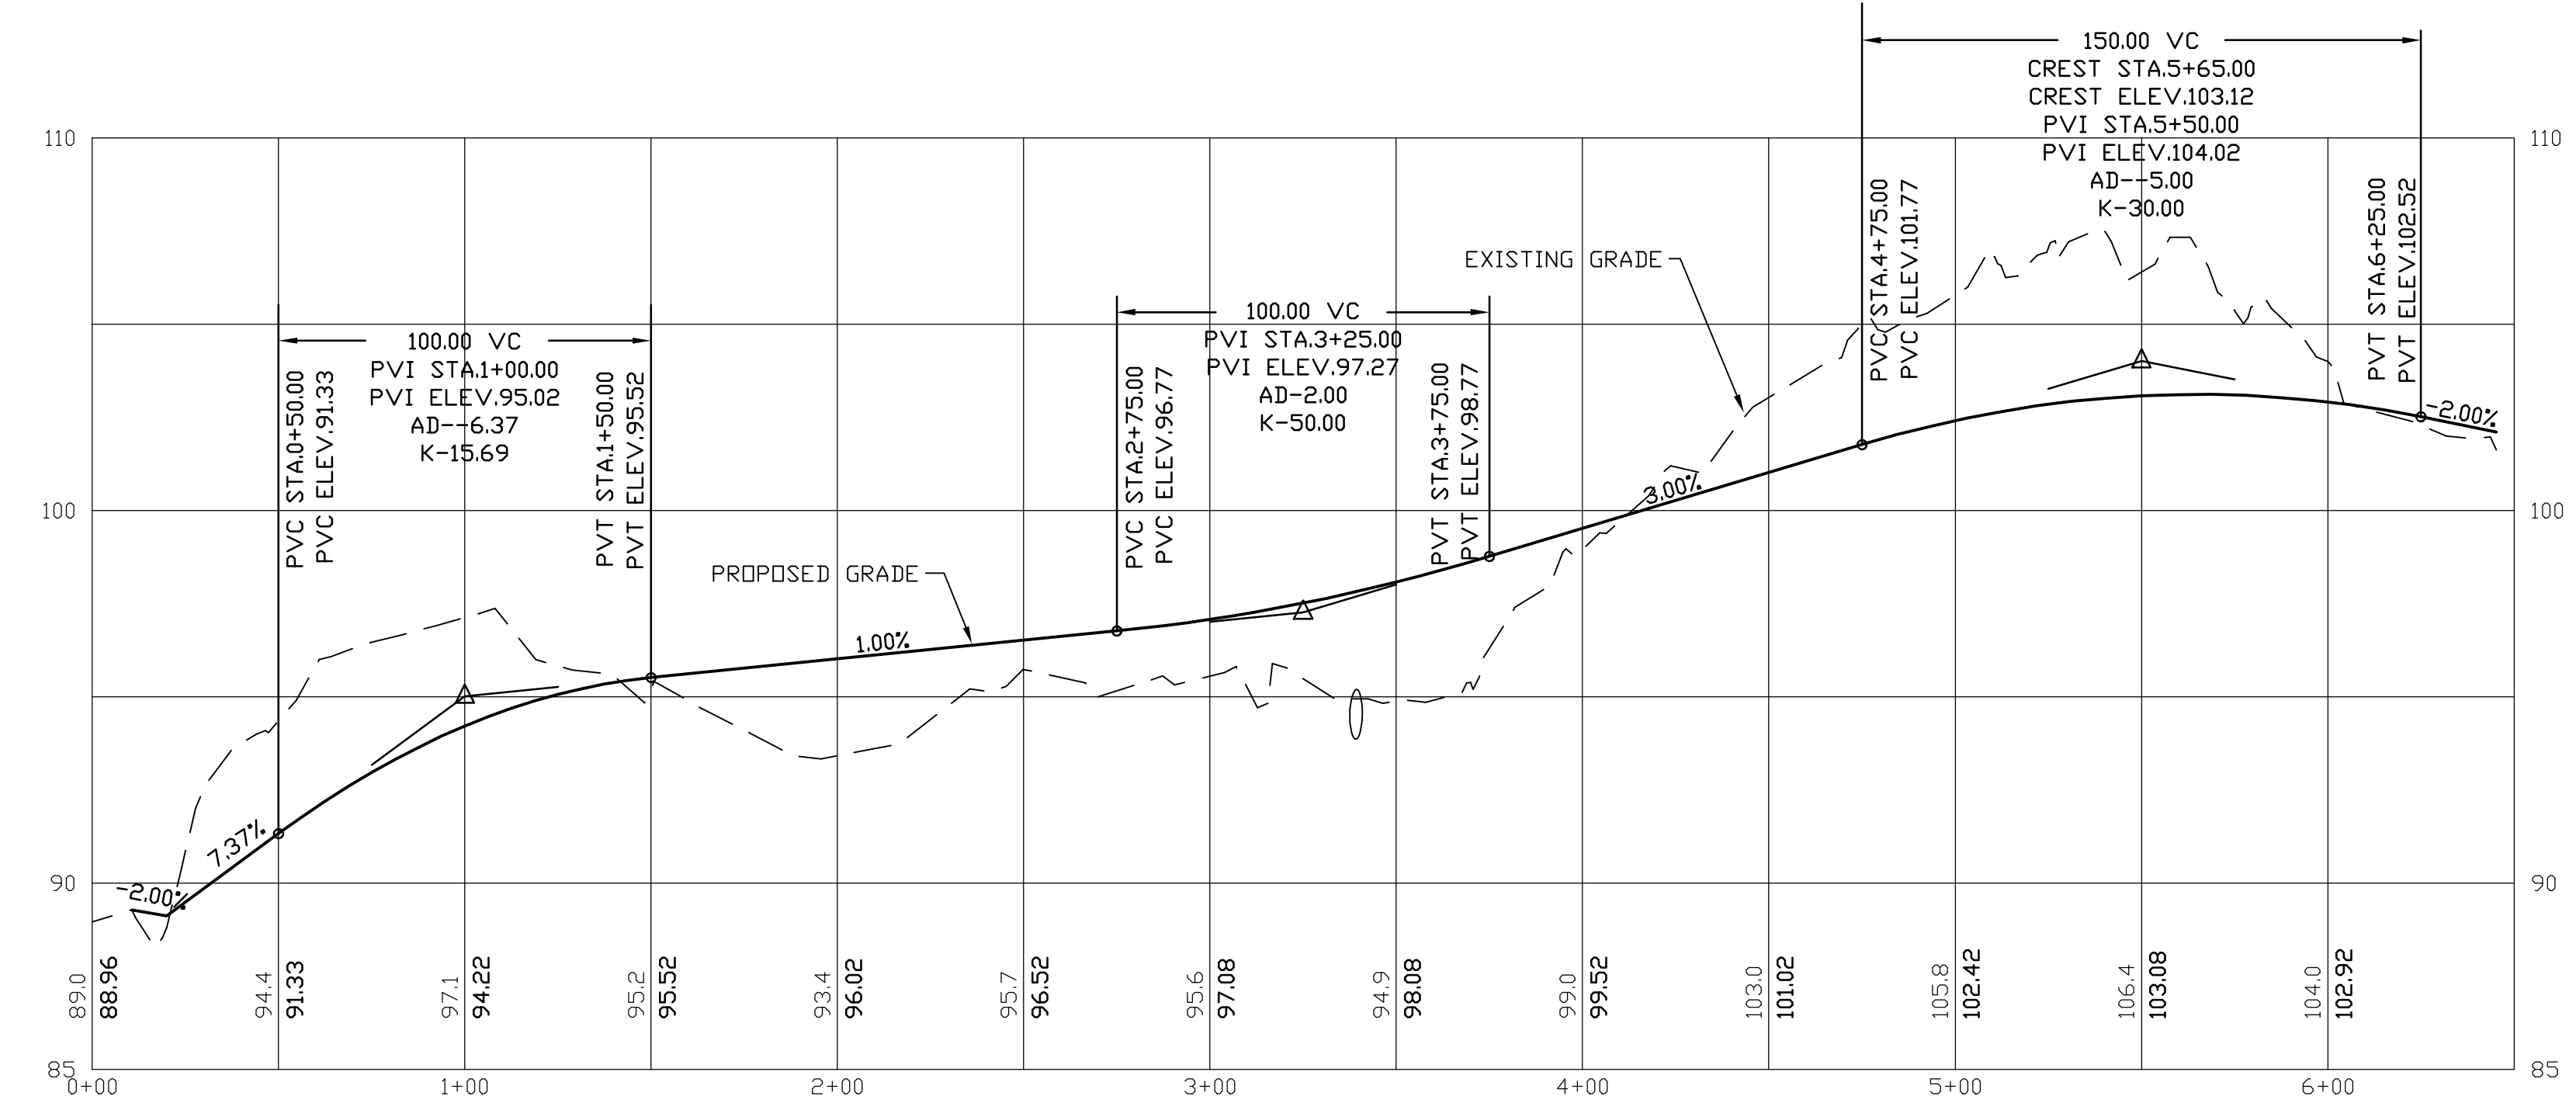


**UTILITY NOTES**


1. THE LOCATIONS OF EXISTING UNDERGROUND UTILITIES ARE APPROXIMATE AND THE LOCATIONS ARE NOT GUARANTEED BY THE OWNER OR ENGINEER. IT IS THE CONTRACTOR'S RESPONSIBILITY TO LOCATE ALL UTILITIES, ANTICIPATE CONFLICTS, REPAIR EXISTING UTILITIES, AND RELOCATE EXISTING UTILITIES REQUIRED TO COMPLETE THE WORK AT NO ADDITIONAL COST TO THE OWNER.
2. SEE EXISTING CONDITIONS PLAN FOR BENCHMARK INFORMATION.
3. ALL SEWER PIPE SHALL BE PVC SDR 35 UNLESS OTHERWISE STATED.
4. COORDINATE ALL WORK WITHIN PUBLIC RIGHT OF WAYS WITH THE TOWN OF STRATHAM AND NHDOT.
5. ALL ELECTRICAL MATERIAL WORKMANSHIP SHALL CONFORM TO THE NATIONAL ELECTRIC CODE, LATEST EDITION, AND ALL APPLICABLE STATE AND LOCAL CODES.
6. THE EXACT LOCATION OF NEW UTILITY SERVICES AND CONNECTIONS SHALL BE COORDINATED WITH THE BUILDING DRAWINGS AND THE APPLICABLE UTILITY COMPANIES.
7. THE CONTRACTOR SHALL OBTAIN, PAY FOR, AND COMPLY WITH ALL REQUIRED PERMITS, ARRANGE FOR ALL INSPECTIONS, AND SUBMIT COPIES OF ACCEPTANCE CERTIFICATES TO THE OWNER PRIOR TO THE COMPLETION OF THIS PROJECT.
8. THE CONTRACTOR SHALL PROVIDE AND INSTALL ALL BOXES, FITTINGS, CONNECTORS, COVER PLATES, AND OTHER MISCELLANEOUS ITEMS NOT NECESSARILY DETAILED ON THESE DRAWINGS TO RENDER INSTALLATION OF UTILITIES COMPLETE AND OPERATIONAL.
9. THE CONTRACTOR SHALL CONTACT "DIG-SAFE" 72 HOURS PRIOR TO COMMENCING CONSTRUCTION. THE CONTRACTOR SHALL HAVE THE "DIG-SAFE" NUMBER ON SITE AT ALL TIMES.
10. CONTRACTOR SHALL COORDINATE ALL ELECTRIC WORK WITH POWER COMPANY.

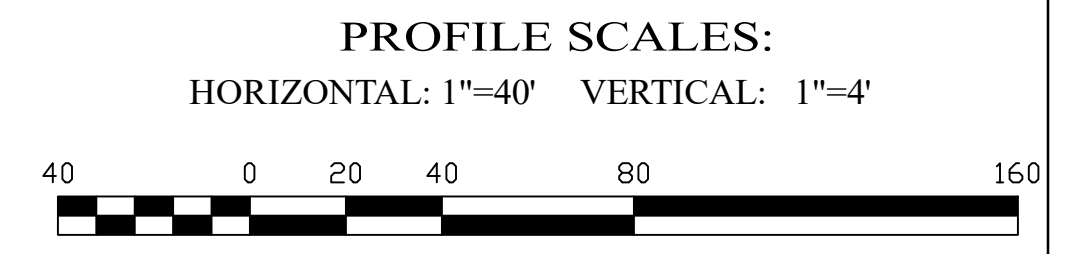


REVISED PER REVIEW COMMENTS	05/05/26
REVISIONS:	DATE:

<b>DRIVEWAY PLAN AND PROFILE WITH UTILITIES</b>	
PLAN FOR: RESIDENTIAL DEVELOPMENT 210 PORTSMOUTH AVE STRATHAM, NH	
DATE: MARCH , 2026	SCALE: 1" = 40'
PROJ. NO: NH-1566	SHEET NO. 7

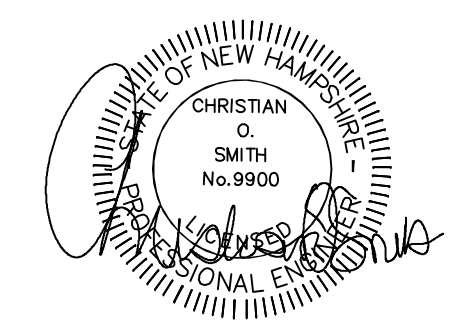

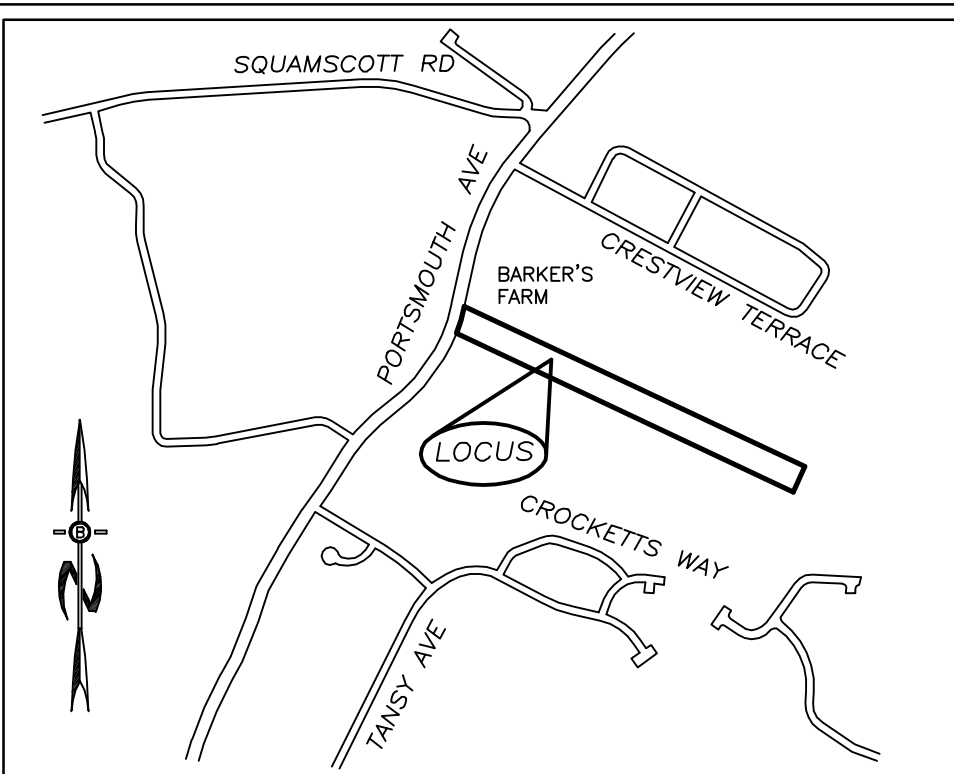

LOCATION MAP

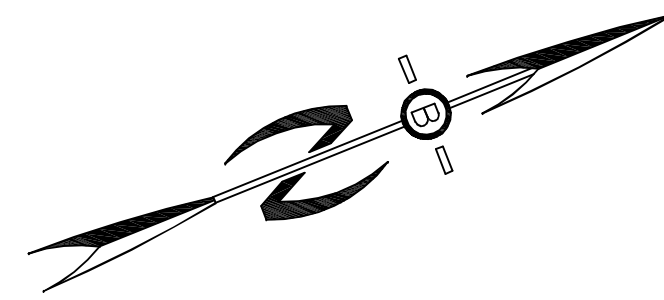

NOTES


1. ALL ELECTRICAL, TELEPHONE, CABLE TELEVISION AND ALARM LINES TO BE UNDERGROUND. LOW PROFILE UTILITY BOX STRUCTURES SHALL BE USED TO THE GREATEST EXTENT.
2. ALL BENCHMARKS AND TOPOGRAPHY SHOULD BE FIELD VERIFIED BY THE CONTRACTOR, ENGINEER TO BE NOTIFIED IMMEDIATELY OF ANY DISCREPANCY.
3. ALL CONSTRUCTION METHODS AND MATERIALS WILL CONFORM TO THE TOWN STANDARD SPECIFICATIONS AND TO N.H.D.O.T. STANDARDS AND REGULATIONS.

PREPARED FOR:



RED BARN PROPERTY LLC  
6 SHORE DRIVE  
GREENLAND, NH 03840




70 PORTSMOUTH AVE,  
THIRD FLOOR, SUITE 2  
STRATHAM, N.H. 03885  
PHONE: 603-583-4860.

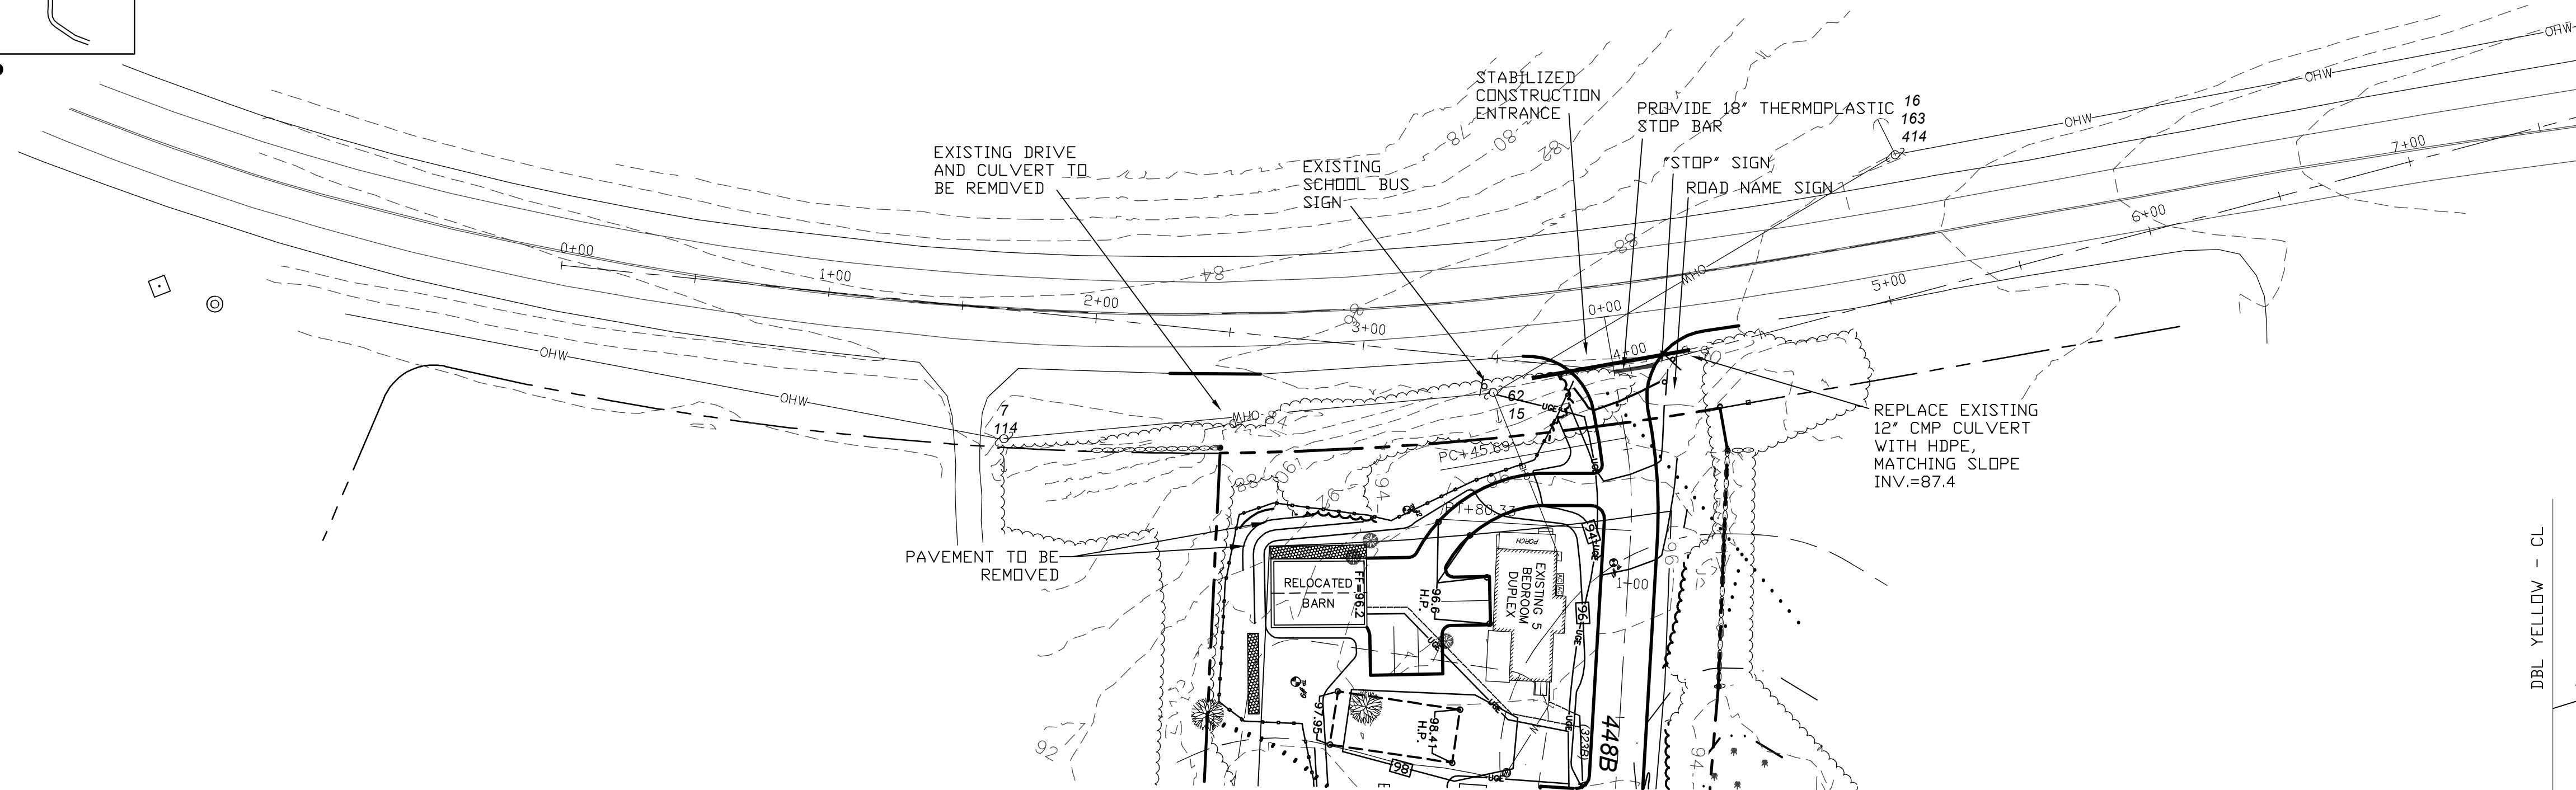

PROFILE SCALES:  
HORIZONTAL: 1"=40' VERTICAL: 1"=4'

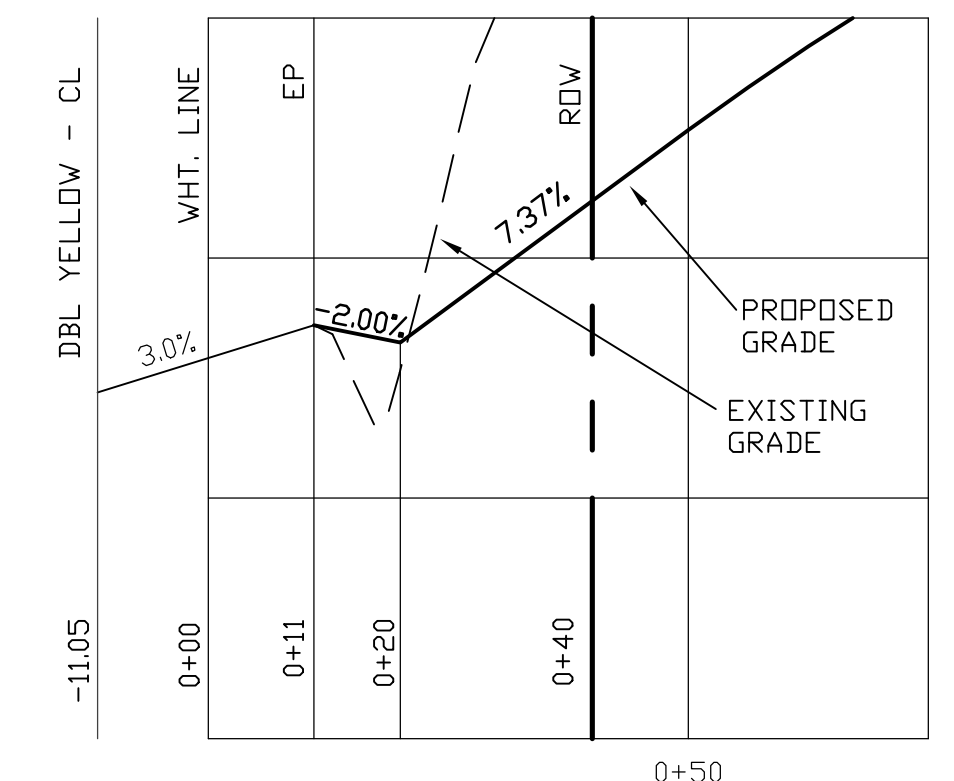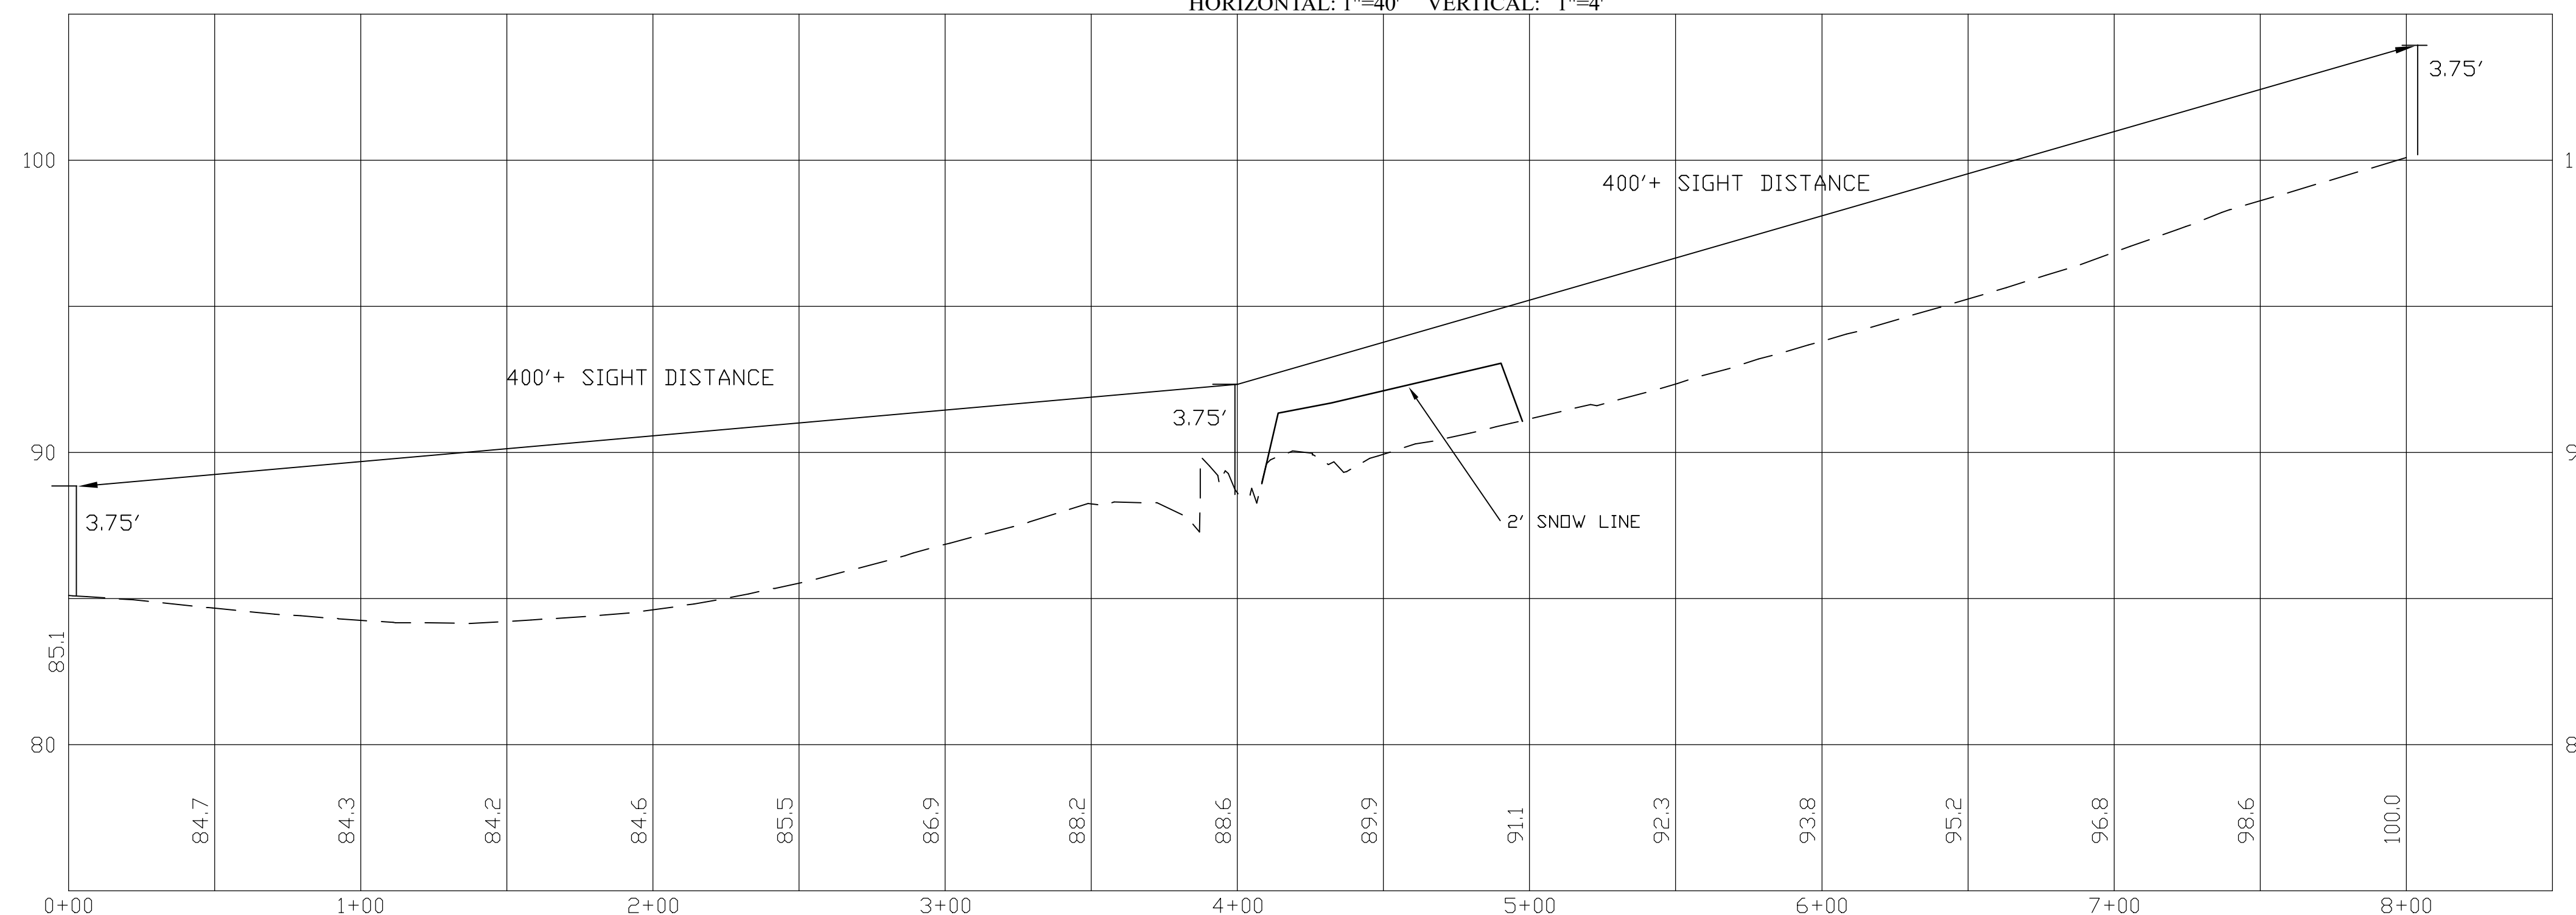

DRIVEWAY PROFILE:  
HORIZONTAL: 1"=20' VERTICAL: 1"=2'

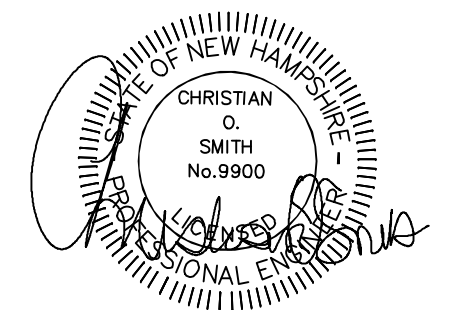

REVISIONS:	DATE:
<b>HIGHWAY ACCESS PLAN</b>	
PLAN FOR: RESIDENTIAL DEVELOPMENT 210 PORTSMOUTH AVE STRATHAM, NH	
DATE: NOV 20 2025	SCALE: 1" = 40'
PROJ. NO: NH-1566	SHEET NO. 8

## WINTER MAINTENANCE

- ALL DISTURBED AREAS THAT DO NOT HAVE AT LEAST 85% VEGETATIVE COVERAGE PRIOR TO OCTOBER 15TH, SHALL BE STABILIZED BY APPLYING MULCH AT A RATE OF 3-4 TONS PER ACRE. ALL SIDE SLOPES, STEEPER THAN 4:1, THAT ARE NOT DIRECTED TO SWALES OR DETENTION BASINS, SHALL BE LINED WITH BIODEGRADABLE/PHOTODEGRADABLE "JUTE MATTING" (EXCELSIOR'S CURLEX II OR EQUAL). ALL OTHER SLOPES SHALL BE MULCHED AND TACKED AT A RATE OF 3-4 TONS PER ACRE. THE APPLICATION OF MULCH AND/OR JUTE MATTING SHALL NOT OCCUR OVER EXISTING SNOW COVER. IF THE SITE IS ACTIVE AFTER NOVEMBER 15TH, ANY SNOW THAT ACCUMULATES ON DISTURBED AREAS SHALL BE REMOVED. PRIOR TO SPRING THAW ALL AREAS WILL BE STABILIZED, AS DIRECTED ABOVE.
- ALL SWALES THAT DO NOT HAVE FULLY ESTABLISHED VEGETATION SHALL BE EITHER LINED WITH TEMPORARY JUTE MATTING OR TEMPORARY STONE CHECK DAMS (APPROPRIATELY SPACED). STONE CHECK DAMS WILL BE MAINTAINED THROUGHOUT THE WINTER MONTHS. IF THE SWALES ARE TO BE MATTED WITH PERMANENT LINERS OR RIPRAP WITH ENGINEERING FABRIC, THIS SHALL BE COMPLETED PRIOR TO WINTER SHUTDOWN OR AS SOON AS THEY ARE PROPERLY GRADED AND SHAPED.
- PRIOR TO OCT. 15TH ALL ROADWAY AND PARKING AREAS SHALL BE BROUGHT UP TO AND THROUGH THE BANK RUN GRAVEL APPLICATION. IF THESE AREAS' ELEVATIONS ARE PROPOSED TO REMAIN BELOW THE PROPOSED SUBGRADE ELEVATION, THE SUBGRADE MATERIAL SHALL BE ROUGHLY CROWNED AND A 3" LAYER OF CRUSHED GRAVEL SHALL BE PLACED AND COMPACTED. THIS WILL ALLOW THE SUBGRADE TO SHED RUNOFF AND WILL REDUCE ROADWAY EROSION. THIS CRUSHED GRAVEL DOES NOT HAVE TO CONFORM TO NH DOT 304.3, BUT SHALL HAVE BETWEEN 15-25% PASSING THE #200 SIEVE AND THE LARGEST STONE SIZE SHALL BE 2". IF THE SITE IS ACTIVE AFTER NOVEMBER 15TH, ANY ACCUMULATED SNOW SHALL BE REMOVED FROM ALL ROADWAY AND PARKING AREAS.
- AFTER OCTOBER 15TH, THE END OF NEW HAMPSHIRE'S AVERAGE GROWING SEASON, NO ADDITIONAL LOAM SHALL BE SPREAD ON SIDE SLOPES AND SWALES. THE STOCKPILES THAT WILL BE LEFT UNDISTURBED UNTIL SPRING SHALL BE SEEDED BY THIS DATE. AFTER OCTOBER 15TH, ANY NEW OR DISTURBED PILES SHALL BE MULCHED AT A RATE OF 3-4 TONS PER ACRE. ALL STOCKPILES THAT WILL REMAIN THROUGHOUT THE WINTER SHALL BE SURROUNDED WITH SILT FENCING.

## TEMPORARY EROSION CONTROL MEASURES

- THE SMALLEST PRACTICAL AREA SHALL BE DISTURBED DURING CONSTRUCTION, BUT NO MORE THAN 5 ACRES OF LAND SHALL BE EXPOSED BEFORE DISTURBED AREAS ARE STABILIZED\*.
  - EROSION, SEDIMENT AND DETENTION MEASURES SHALL BE INSTALLED AS SHOWN ON THE PLANS AND AT LOCATIONS AS REQUIRED OR DIRECTED BY THE ENGINEER ALL DISTURBED AREAS SHALL BE RETURNED TO ORIGINAL GRADES AND ELEVATIONS.
  - DISTURBED AREAS SHALL BE LOAMED WITH A MINIMUM OF 4" OF LOAM AND SEEDED WITH NOT LESS THAN 1.10 POUNDS OF SEED PER 1000 SQUARE FEET OF AREA. (48 POUNDS PER ACRE) SEE SEED SPECIFICATIONS THIS SHEET.
  - SILT FENCES AND OTHER EROSION CONTROLS SHALL BE INSPECTED WEEKLY AND AFTER EVERY RAIN EVENT GREATER THAN 0.5" DURING THE LIFE OF THE PROJECT. ALL DAMAGED AREAS SHALL BE REPAIRED, SEDIMENT DEPOSITS SHALL PERIODICALLY BE REMOVED AND DISPOSED OF.
  - AFTER ALL DISTURBED AREAS HAVE BEEN STABILIZED, THE TEMPORARY EROSION CONTROL MEASURES ARE TO BE REMOVED AND THE AREA DISTURBED BY THE REMOVAL SMOOTHED AND RE-VEGETATED.
  - AREAS MUST BE SEEDED AND MULCHED WITHIN 3 DAYS OF FINAL GRADING, PERMANENTLY STABILIZED WITHIN 15 DAYS OF FINAL GRADING, OR TEMPORARILY STABILIZED WITHIN 30 DAYS OF INITIAL DISTURBANCE OF SOIL.
- \* AN AREA SHALL BE CONSIDERED STABLE IF ONE OF THE FOLLOWING HAS OCCURRED:
- BASE COURSE GRAVELS HAVE BEEN INSTALLED IN AREAS TO BE PAVED.
  - A MINIMUM OF 85% VEGETATED GROWTH HAS BEEN ESTABLISHED.
  - A MINIMUM OF 3 INCHES OF NON-EROSIVE MATERIAL SUCH AS RIPRAP HAS BEEN INSTALLED.
  - EROSION CONTROL BLANKETS HAVE BEEN PROPERLY INSTALLED.

## CONSTRUCTION SPECIFICATIONS



- STRUCTURES SHALL BE INSTALLED ACCORDING TO THE DIMENSIONS SHOWN ON THE PLANS AT THE APPROPRIATE SPACING.
- CONSTRUCTION OPERATIONS SHALL BE CARRIED OUT IN SUCH A MANNER SO THAT EROSION AND AIR AND WATER POLLUTION WILL BE MINIMIZED.
- WHEN TIMBER STRUCTURES ARE USED, THE TIMBER SHALL EXTEND AT LEAST 18" INTO THE SOIL.
- STRAW BALES SHALL BE ANCHORED INTO THE SOIL USING 2" X 2" STAKES DRIVEN THROUGH THE BALES AND AT LEAST 18 INCHES INTO THE SOIL.
- SEEDING, FERTILIZING, AND MULCHING SHALL CONFORM TO THE RECOMMENDATIONS IN THE APPROPRIATED VEGETATIVE BMP.
- STRUCTURES SHALL BE REMOVED FROM THE CHANNEL WHEN THEIR USEFUL LIFE HAS BEEN COMPLETED.
- THROUGHOUT THE DURATION OF CONSTRUCTION ACTIVITIES THE CONTRACTOR SHALL TAKE PRECAUTIONS AND INSTRUCTIONS FROM THE PLANNING DEPARTMENT IN ORDER TO PREVENT, ABATE AND CONTROL THE EMISSION OF FUGITIVE DUST INCLUDING BUT NOT LIMITED TO WETTING, COVERING, SHIELDING, OR VACUUMING.
- THE NH COMMISSIONER OF AGRICULTURE PROHIBITS THE COLLECTION, POSSESSION, IMPORTATION, TRANSPORTATION, SALE, PROPAGATION, TRANSPLANTATION, OR CULTIVATION OF PLANTS BANNED BY NH LAW RSA 430:53 AND NH CODE ADMINISTRATIVE RULES AGR 3800. THE PROJECT SHALL MEET ALL REQUIREMENTS AND THE INTENT OF . RSA 430:53 AND AGR 3800 RELATIVE TO INVASIVE SPECIES
- THE CONSTRUCTION SITE OPERATOR AND OWNER SHALL SUBMIT A NOTICE OF INTENT (NOI) TO USEPA, WASHINGTON, DC, STORMWATER NOTICE PROCESSING CENTER AT LEAST FOURTEEN DAYS PRIOR TO COMMENCEMENT OF WORK ON SITE. EPA WILL POST THE NOI AT <http://cfpub.epa.gov/npdes/stormwater/noi/noisearch.cfm>. AUTHORIZATION IS GRANTED UNDER THE PERMIT ONCE THE NOI IS SHOWN IN "ACTIVE STATUS".

## CONSTRUCTION SEQUENCE

- CUT AND REMOVE TREES IN CONSTRUCTION AREAS AS REQUIRED OR DIRECTED.
- CONSTRUCT AND/OR INSTALL TEMPORARY AND PERMANENT SEDIMENT EROSION AND DETENTION CONTROL FACILITIES AS REQUIRED. EROSION, SEDIMENT AND DETENTION CONTROL FACILITIES SHALL BE INSTALLED AND STABILIZED PRIOR TO ANY EARTH MOVING OPERATION AND PRIOR TO DIRECTING RUNOFF TO THEM. RUNOFF MUST BE DIRECTED TO TEMPORARY PRACTICES UNTIL STORMWATER BMP'S ARE STABILIZED.
- CLEAR, CUT, GRUB AND DISPOSE OF DEBRIS IN APPROVED FACILITIES. STUMPS AND DEBRIS ARE TO BE REMOVED FROM SITE AND DISPOSED OF PER STATE AND LOCAL REGULATIONS.
- EXCAVATE AND STOCKPILE TOPSOIL /LOAM. ALL AREAS SHALL BE STABILIZED IMMEDIATELY AFTER GRADING.
- CONSTRUCT TEMPORARY CULVERTS AS REQUIRED OR DIRECTED.
- CONSTRUCT THE ROADWAY/DRIVEWAYS AND ITS ASSOCIATED DRAINAGE STRUCTURES. ALL ROADWAYS, PARKING AREAS, AND CUT/FILL SLOPES SHALL BE STABILIZED AND/OR LOAMED AND SEEDED WITHIN 72-HOURS OF ACHIEVING FINISH GRADE AS APPLICABLE.
- INSTALL PIPE AND CONSTRUCTION ASSOCIATED APPURTENANCES AS REQUIRED OR DIRECTED. ALL DISTURBED AREAS SHALL STABILIZED IMMEDIATELY AFTER GRADING.
- BEGIN PERMANENT AND TEMPORARY SEEDING AND MULCHING. ALL CUT AND FILL SLOPES AND DISTURBED AREAS SHALL BE SEEDED OR MULCHED AS REQUIRED, OR DIRECTED.
- DAILY OR AS REQUIRED, CONSTRUCT TEMPORARY BERMS, DRAINAGE CHECK DAMS, DITCHES, SEDIMENT TRAPS, ETC. TO PREVENT EROSION ON THE SITE AND PREVENT ANY SILTATION OF ABUTTING WATERS OR PROPERTY.
- INSPECT AND MAINTAIN ALL EROSION AND SEDIMENT CONTROL MEASURES DURING CONSTRUCTION
- COMPLETE PERMANENT SEEDING AND LANDSCAPING
- REMOVE TEMPORARY EROSION CONTROL MEASURES AFTER SEEDING AREAS HAVE ESTABLISHED THEMSELVES AND SITE IMPROVEMENTS ARE COMPLETE. SMOOTH AND REVEGETATE ALL DISTURBED AREAS.
- ALL SWALES AND DRAINAGE STRUCTURES WILL BE CONSTRUCTED AND STABILIZED PRIOR TO HAVING RUNOFF DIRECTED TO THEM.
- FINISH PAVING ALL ROADWAYS/DRIVEWAYS.
- LOT DISTURBANCE OTHER THAN THAT SHOWN ON THE APPROVED PLANS SHALL NOT COMMENCE UNTIL THE ROADWAY HAS THE BASE COURSE TO DESIGN ELEVATION AND THE ASSOCIATED DRAINAGE IS COMPLETE AND STABLE.

## CONSTRUCTION SPECIFICATIONS FOR STRAW OR HAY BALE BARRIERS

- STRUCTURES SHALL BE INSTALLED ACCORDING TO THE DIMENSIONS SHOWN ON THE PLANS AT THE APPROPRIATE SPACING.
- CONSTRUCTION OPERATIONS SHALL BE CARRIED OUT IN SUCH A MANNER SO THAT EROSION AND AIR AND WATER POLLUTION WILL BE MINIMIZED.
- WHEN HAY BALES ARE USED, THE BALES SHALL BE EMBEDDED AT LEAST 4 INCHES INTO THE SOIL. WHEN TIMBER STRUCTURES ARE USED, THE TIMBER SHALL EXTEND AT LEAST 18 INCHES INTO THE SOIL.
- HAY OR STRAW BALES SHALL BE ANCHORED INTO THE SOIL USING 2" X 2" STAKES DRIVEN THROUGH THE BALES AND AT LEAST 18 INCHES INTO THE SOIL.
- SEEDING, FERTILIZING, AND MULCHING SHALL CONFORM TO THE RECOMMENDATIONS IN THE APPROPRIATE VEGETATIVE BMP.
- STRUCTURES SHALL BE REMOVED FROM THE CHANNEL WHEN THEIR USEFUL LIFE HAS BEEN COMPLETED.

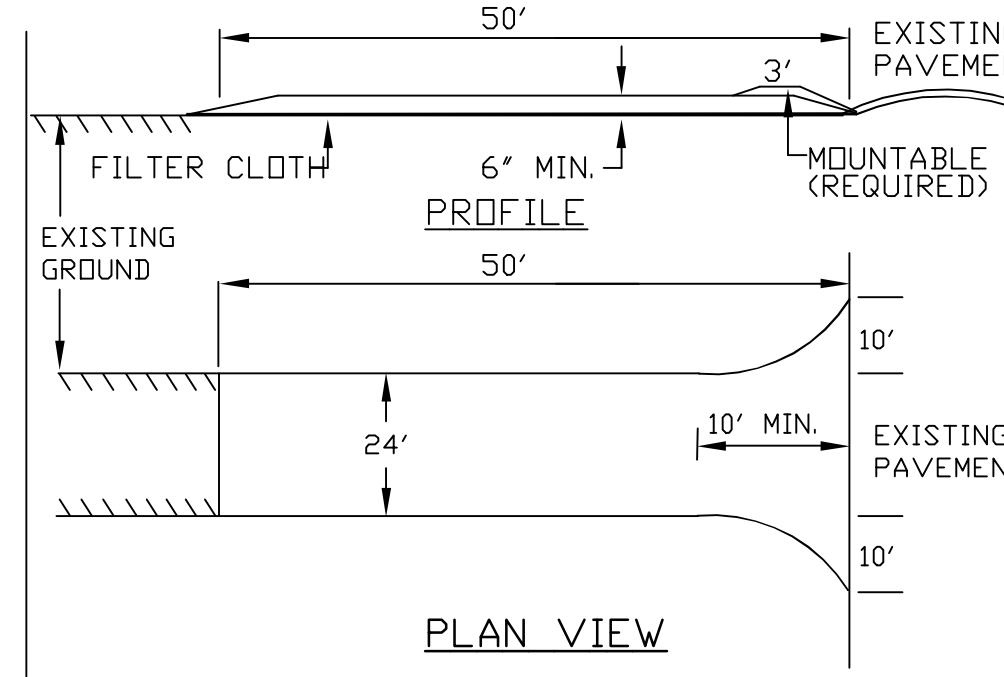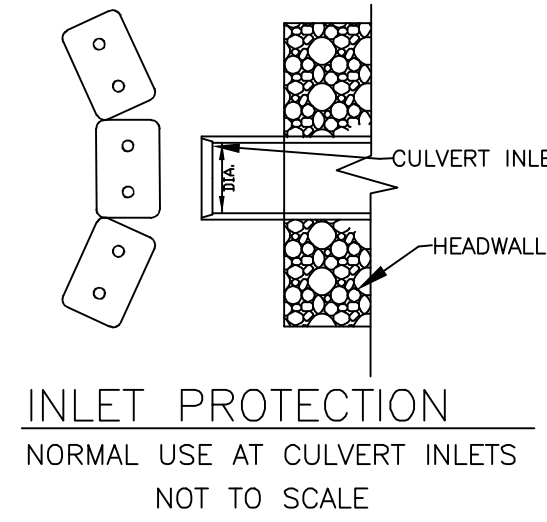


- STONE FOR A STABILIZED CONSTRUCTION ENTRANCE SHALL BE 3 INCH STONE, RECLAIMED STONE, OR RECYCLED CONCRETE EQUIVALENT.
- THE LENGTH OF THE STABILIZED ENTRANCE SHALL NOT BE LESS THAN 50 FEET, EXCEPT FOR A SINGLE RESIDENTIAL LOT WHERE A 30 FOOT MINIMUM LENGTH WOULD APPLY.
- THE THICKNESS OF THE STONE FOR THE STABILIZED ENTRANCE SHALL NOT BE LESS THAN 6 INCHES.
- THE WIDTH OF THE ENTRANCE SHALL NOT BE LESS THAN THE FULL WIDTH OF THE ENTRANCE WHERE INGRESS OR EGRESS OCCURS OR 10 FEET, WHICH EVER IS GREATER. 5. GEOTEXTILE FILTER CLOTH SHALL BE PLACED OVER THE ENTIRE AREA PRIOR TO PLACING THE STONE. FILTER CLOTH IS NOT REQUIRED FOR A SINGLE FAMILY RESIDENCE LOT.
- ALL SURFACE WATER THAT IS FLOWING TO OR DIVERTED TOWARD THE CONSTRUCTION ENTRANCE SHALL BE PIPED BENEATH THE ENTRANCE, IF PIPING IS IMPRACTICAL, A BERM WITH 5:1 SLOPES THAT CAN BE CROSSED BY VEHICLES MAY BE SUBSTITUTED FOR THE PIPE.
- THE ENTRANCE SHALL BE MAINTAINED IN A CONDITION THAT WILL PREVENT TRACKING OR FLOWING OF SEDIMENT ONTO PUBLIC RIGHTS-OF-WAY. THIS MAY REQUIRE PERIODIC TOP DRESSING WITH ADDITIONAL STONE AS CONDITIONS DEMAND AND REPAIR AND/OR CLEAN OUT OF ANY MEASURES USED TO TRAP SEDIMENT. ALL SEDIMENT SPILLED, WASHED, OR TRACKED ONTO PUBLIC RIGHT-OF-WAY MUST BE REMOVED PROMPTLY.

## STABILIZED CONSTRUCTION ENTRANCE

## SEEDING SPECIFICATIONS

- GRADING AND SHAPING
  - SLOPES SHALL NOT BE STEEPER THAN 2:1:3:1 SLOPES OR FLATTER ARE PREFERRED. WHERE MOWING WILL BE DONE, 3:1 SLOPES OR FLATTER ARE RECOMMENDED.
- SEEDBED PREPARATION
  - SURFACE AND SEEPAGE WATER SHOULD BE DRAINED OR DIVERTED FROM THE SITE TO PREVENT DROWNING OR WINTER KILLING OF THE PLANTS.
  - STONES LARGER THAN 4 INCHES AND TRASH SHOULD BE REMOVED BECAUSE THEY INTERFERE WITH SEEDING AND FUTURE MAINTENANCE OF THE AREA. WHERE FEASIBLE, THE SOIL SHOULD BE TILLED TO A DEPTH OF ABOUT 4 INCHES TO PREPARE A SEEDBED AND MIX FERTILIZER AND LIME INTO THE SOIL. THE SEEDBED SHOULD BE LEFT IN REASONABLY FIRM AND SMOOTH CONDITION. THE LAST TILLAGE OPERATION SHOULD BE PERFORMED ACROSS THE SLOPE WHEREVER PRACTICAL.
- ESTABLISHING A STAND
  - LIME AND FERTILIZER SHOULD BE APPLIED PRIOR TO OR AT THE TIME OF SEEDING AND INCORPORATED INTO THE SOIL. KINDS AND AMOUNTS OF LIME AND FERTILIZER SHOULD BE BASED ON AN EVALUATION OF SOIL TESTS. WHEN A SOIL TEST IS NOT AVAILABLE, THE FOLLOWING MINIMUM AMOUNTS SHOULD BE APPLIED:
    - AGRICULTURAL LIMESTONE, 2 TONS PER ACRE OR 100 LBS PER 1,000 SQ. FT.
    - NITROGEN(N), 50 LBS PER ACRE OR 1.1 LBS PER 1,000 SQ.FT.
    - PHOSPHATE(P2O5), 100 LBS PER ACRE OR 2.2 LBS PER 1,000 SQ.FT.
    - POTASH(K2O), 100 LBS PER ACRE OR 2.2 LBS PER 1,000 SQ.FT.
 (NOTE: THIS IS THE EQUIVALENT OF 500 LBS PER ACRE OF 10-20-20 FERTILIZER OR 1,000 LBS PER ACRE OF 5-10-10)
  - SEED SHOULD BE SPREAD UNIFORMLY BY THE METHOD MOST APPROPRIATE FOR THE SITE. METHODS INCLUDE BROADCASTING, DRILLING AND HYDROSEEDING. WHERE BROADCASTING IS USED, COVER SEED WITH .25 INCH OF SOIL OR LESS, BY CULTIPACKING OR RAKING.
  - REFER TO TABLE(G-E1 THIS SHEET) FOR APPROPRIATE SEED MIXTURES AND TABLE(H-E1 THIS SHEET) FOR RATES OF SEEDING. ALL LEGUMES (CROWN VETCH, BIRDS FOOT TREFLOIL, AND FLAT PEA) MUST BE INOCULATED WITH THEIR SPECIFIC INOCULANT.
  - WHEN SEEDED AREAS ARE MULCHED, PLANTINGS MAY BE MADE FROM EARLY SPRING TO EARLY OCTOBER. WHEN SEEDED AREAS ARE NOT MULCHED, PLANTINGS SHOULD BE MADE FROM EARLY SPRING TO MAY 20 OR FROM AUGUST 10 TO SEPTEMBER 1.
- MULCH
  - HAY, STRAW, OR OTHER MULCH, WHEN NEEDED, SHOULD BE APPLIED IMMEDIATELY AFTER SEEDING.
  - MULCH WILL BE HELD IN PLACE USING APPROPRIATE TECHNIQUES FROM THE BEST MANAGEMENT PRACTICE FOR MULCHING. HAY OR STRAW MULCH SHALL BE PLACED AT A RATE OF 90 LBS PER 1000 SQ. FT.
- MAINTENANCE TO ESTABLISH A STAND
  - PLANTED AREA SHOULD BE PROTECTED FROM DAMAGE BY FIRE, GRAZING, TRAFFIC, AND DENSE WEED GROWTH.
  - FERTILIZATION NEEDS SHOULD BE DETERMINED BY ONSITE INSPECTIONS. SUPPLEMENTAL FERTILIZER IS USUALLY THE KEY TO FULLY COMPLETE THE ESTABLISHMENT OF THE STAND BECAUSE MOST PERENNIAL STAKE 2 TO 3 YEARS TO BECOME ESTABLISHED.
  - IN WATERWAYS, CHANNELS, OR SWALES WHERE UNIFORM FLOW CONDITIONS ARE ANTICIPATED, OCCASIONAL MOWING MAY BE NECESSARY TO CONTROL GROWTH OF WOODY VEGETATION.

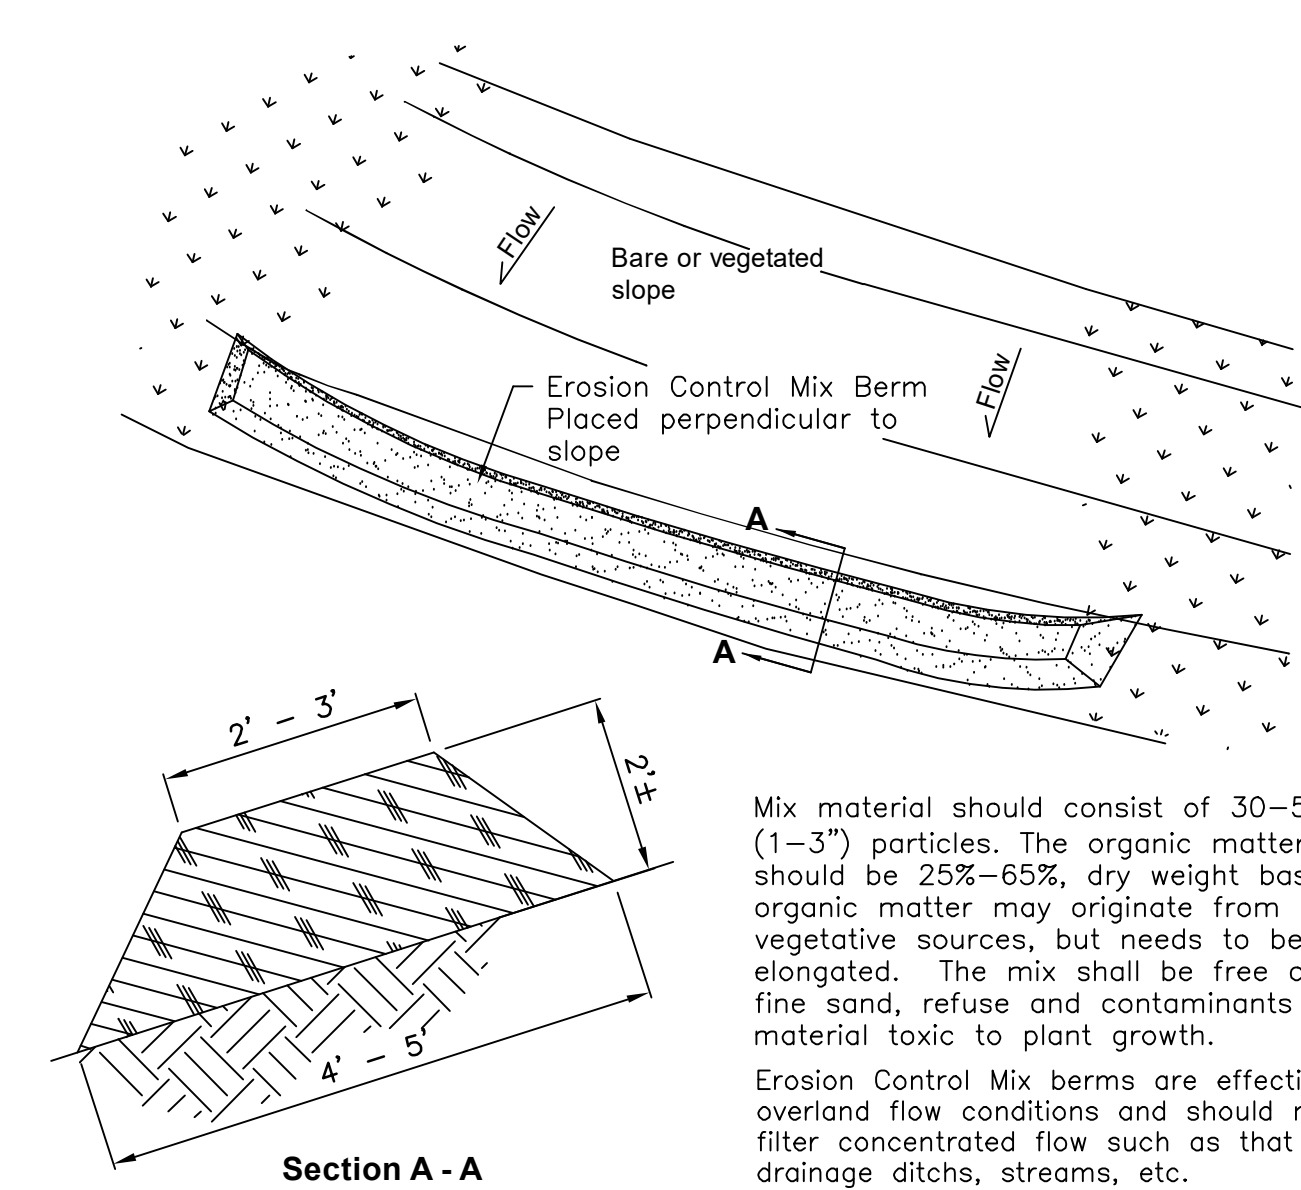

Mix material should consist of 30-50% large (1-3") particles. The organic matter content should be 25%-65%, dry weight basis. The organic matter may originate from a variety of vegetative sources, but needs to be fibrous and elongated. The mix shall be free of silt, clay, fine sand, refuse and contaminants or any material toxic to plant growth.


Erosion Control Mix berms are effective filters for overland flow conditions and should not be used to filter concentrated flow such as that found in drainage ditches, streams, etc.

## CONSTRUCTION SPECIFICATIONS

- WOVEN WIRE FENCE TO BE FASTENED SECURELY TO FENCE POSTS WITH WIRE TIES OR STAPLES AND FILTER CLOTH SHALL BE FASTENED TO WOVEN WIRE EVERY 24" AT TOP MID AND BOTTOM SECTIONS AND BE EMBEDDED INTO GROUND A MINIMUM OF 8". 2. THE FENCE POSTS SHALL BE A MINIMUM 48" LONG, SPACED A MAXIMUM 10' APART, AND DRIVEN A MINIMUM OF 16" INTO THE GROUND.
- WHEN TWO SECTIONS OF FILTER CLOTH ADJOIN EACH OTHER, THE ENDS OF THE FABRIC SHALL BE OVERLAPPED BY SIX INCHES, FOLDED AND STAPLED TO PREVENT SEDIMENT FROM BY-PASSING.
- MAINTENANCE SHALL BE PERFORMED AS NEEDED AND SEDIMENT REMOVED WHEN "BULGES" DEVELOP IN THE SILT FENCE AND PROPERLY DISPOSED OF.
- PLACE THE ENDS OF THE SILT FENCE UP CONTOUR TO PROVIDE FOR SEDIMENT STORAGE.
- SILT FENCES SHALL BE REMOVED WHEN NO LONGER NEEDED AND THE SEDIMENT COLLECTED SHALL BE DISPOSED AS DIRECTED BY THE ENGINEER. THE AREA DISTURBED BY THE REMOVAL SHALL BE SMOOTHED AND RE-VEGETATED

## MAINTENANCE

- SILT FENCES SHALL BE INSPECTED IMMEDIATELY AFTER EACH RAINFALL AND AT LEAST DAILY DURING PROLONGED RAINFALL. ANY REPAIRS THAT ARE REQUIRED SHALL BE MADE IMMEDIATELY.
- IF THE FABRIC ON A SILT FENCE SHOULD DECOMPOSE OR BECOME INEFFECTIVE DURING THE EXPECTED LIFE OF THE FENCE, THE FABRIC SHALL BE REPLACED PROMPTLY.
- SEDIMENT DEPOSITS SHOULD BE INSPECTED AFTER EVERY STORM EVENT. THE DEPOSITS SHOULD BE REMOVED WHEN THEY REACH APPROXIMATELY ONE HALF THE HEIGHT OF THE BARRIER.
- SEDIMENT DEPOSITS THAT ARE REMOVED OR LEFT IN PLACE AFTER THE FABRIC HAS BEEN REMOVED SHALL BE GRADED TO CONFORM WITH THE EXISTING TOPOGRAPHY AND VEGETATED.

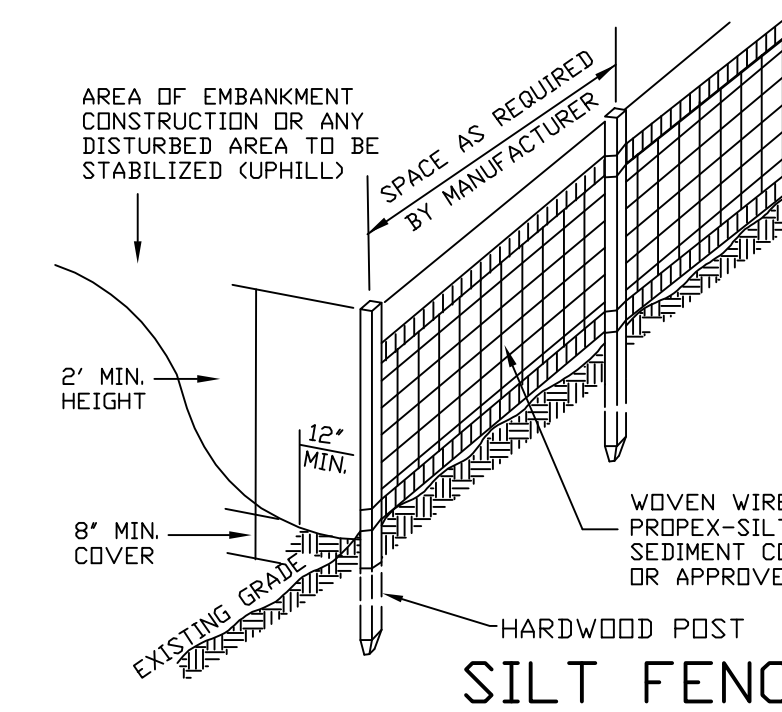

## SEEDING GUIDE

USE	SEEDING MIXTURE 1/	DROUGHTY	WELL DRAINED	MODERATELY WELL DRAINED	POORLY DRAINED
STEEP CUTS AND FILLS, BORROW AND DISPOSAL AREAS	A	FAIR	GOOD	GOOD	FAIR
	B	POOR	GOOD	FAIR	FAIR
	C	POOR	GOOD	EXCELLENT	GOOD
	E	FAIR	FAIR	EXCELLENT	EXCELLENT
WATERWAYS, EMERGENCY SPILLWAYS, AND OTHER CHANNELS WITH FLOWING WATER	A	GOOD	GOOD	GOOD	FAIR
	C	GOOD	EXCELLENT	EXCELLENT	FAIR
	D	GOOD	EXCELLENT	EXCELLENT	FAIR
	E	GOOD	EXCELLENT	EXCELLENT	FAIR
LIGHTLY USED PARKING LOTS, ODD AREAS, UNUSED LANDS, AND LOW INTENSITY USE RECREATION SITES.	A	GOOD	GOOD	GOOD	FAIR
	B	GOOD	GOOD	FAIR	POOR
	C	GOOD	EXCELLENT	EXCELLENT	FAIR
	D	FAIR	GOOD	GOOD	EXCELLENT
PLAY AREAS AND ATHLETIC FIELDS. (TOPSOIL IS ESSENTIAL FOR GOOD TURF)	F	FAIR	EXCELLENT	EXCELLENT	2/
	G	FAIR	EXCELLENT	EXCELLENT	2/

GRAVEL PIT. SEE NH-PM-24 IN APPENDIX FOR RECOMMENDATION REGARDING RECLAMATION OF SAND AND GRAVEL PITS.

1/ REFER TO SEEDING MIXTURES AND RATES IN TABLE 7-36.

2/ POORLY DRAINED SOILS ARE NOT DESIRABLE FOR USE AS PLAYING AREA AND ATHLETIC FIELDS.


NOTE: TEMPORARY SEED MIX FOR STABILIZATION OF TURF SHALL BE WINTER RYE OR DATS AT A RATE OF 2.5 LBS. PER 1000 S.F. AND SHALL BE PLACED PRIOR TO OCT. 15, IF PERMANENT SEEDING NOT YET COMPLETE.

PREPARED FOR:

RED BARN PROPERTY LLC  
6 SHORE DRIVE  
GREENLAND, NH 03840



70 PORTSMOUTH AVE,  
THIRD FLOOR, SUITE 2  
STRATHAM, N.H. 03885  
PHONE: 603-583-4860,

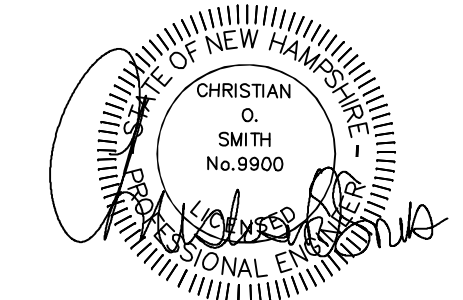

SEEDING RATES		
MIXTURE	POUNDS PER ACRE	POUNDS PER 1,000 Sq. Ft.
A. TALL FESCUE	20	0.45
CREeping RED FESCUE	20	0.45
RED TOP	2	0.05
TOTAL	42	0.95
B. TALL FESCUE	15	0.35
CREeping RED FESCUE	10	0.25
CROWN VETCH OR	15	0.35
FLAT PEA	30	0.75
TOTAL	40 OR 55	0.95 OR 1.35
C. TALL FESCUE	20	0.45
CREeping RED FESCUE	20	0.45
BIRDS FOOT TREFLOIL	8	0.20
TOTAL	48	1.10
D. TALL FESCUE	20	0.45
FLAT PEA	30	0.75
TOTAL	50	1.20
E. CREeping RED FESCUE 1/	50	1.15
KENTUCKY BLUEGRASS 1/	30	1.15
TOTAL	100	2.30
F. TALL FESCUE 1	150	3.60

1/ FOR HEAVY USE ATHLETIC FIELDS CONSULT THE UNIVERSITY OF NEW HAMPSHIRE COOPERATIVE EXTENSION TURF SPECIALIST FOR CURRENT VARIETIES AND SEEDING RATES.


REVISED PER REVIEW COMMENTS: 05/05/26

REVISIONS: DATE:

## EROSION & SEDIMENTATION

PLAN FOR:  
RESIDENTIAL DEVELOPMENT  
210 PORTSMOUTH AVE  
STRATHAM, NH


DATE:	MAR 11, 2026	SCALE	NTS
PROJ. NO:	NH-1566	SHEET NO.	9

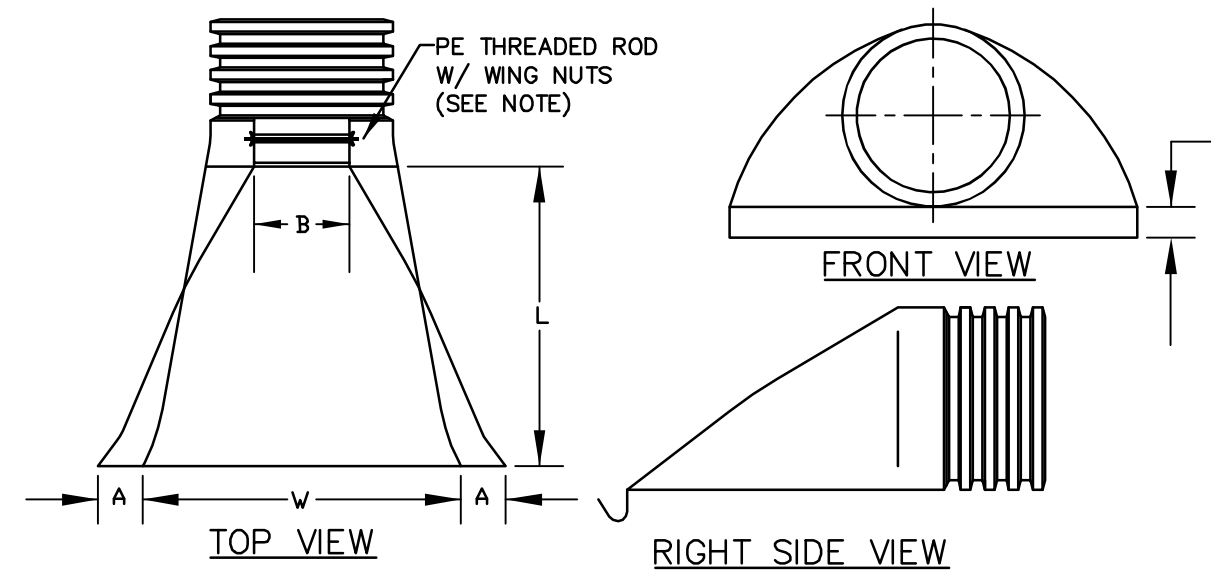

PART No.	PIPE SIZE	A	B(MAX)	H	L	W
1510-NP	15" 375 mm	6.5" 165 mm	10" 254 mm	6.5" 165 mm	25" 635 mm	29" 735 mm
1810-NP	18" 450 mm	7.5" 190 mm	15" 380 mm	6.5" 165 mm	32" 812 mm	35" 890 mm
2410-NP	24" 600 mm	7.5" 190 mm	18" 450 mm	6.5" 165 mm	36" 900 mm	45" 1140 mm
3010-NP	30" 750 mm	10.5" 266 mm	N/A	7.0" 178 mm	53" 1345 mm	68" 1725 mm
3610-NP	36" 900 mm	10.5" 266 mm	N/A	7.0" 178 mm	53" 1345 mm	68" 1725 mm

NOTE: PE THREADED ROD W/ WING NUTS PROVIDED FOR END SECTIONS 15"-24". 30" & 36" END SECTIONS TO BE WELDED PER MANUFACTURER'S RECOMMENDATIONS.

**ADS N-12 FLARED END SECTIONS**  
NOT TO SCALE (ALL DIMENSIONS ARE NOMINAL)

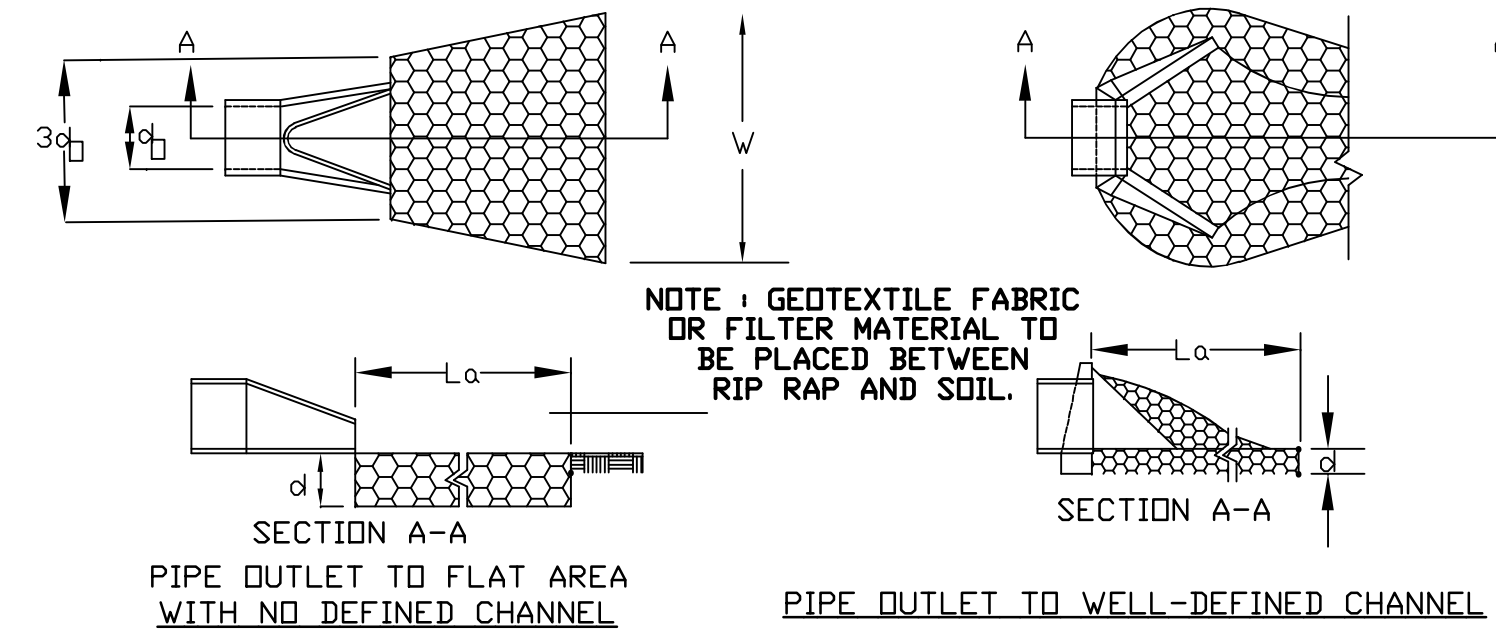

**CONSTRUCTION SPECIFICATIONS**


1. THE SUB GRADE FOR THE FILTER MATERIAL, GEOTEXTILE FABRIC, AND RIP RAP SHALL BE PREPARED TO THE LINES AND GRADES SHOWN ON THE PLANS.
2. THE ROCK OR GRAVEL USED FOR FILTER OF RIP RAP SHALL CONFORM TO THE SPECIFIED GRADATION. 3. GEOTEXTILE FABRICS SHALL BE PROTECTED FROM PUNCTURE OR TEARING DURING THE PLACEMENT OF THE ROCK RIP RAP. DAMAGED AREAS IN THE FABRIC SHALL BE REPAIRED BY PLACING A PIECE OF FABRIC OVER THE DAMAGED AREA OR BY COMPLETE REPLACEMENT OF THE FABRIC. ALL OVERLAPS REQUIRED FOR REPAIRS OR JOINING TWO PIECES OF FABRIC SHALL BE A MINIMUM OF 12 INCHES.
4. STONE FOR THE RIP RAP MAY BE PLACED BY EQUIPMENT AND SHALL BE CONSTRUCTED TO THE FULL LAYER THICKNESS IN ONE OPERATION AND IN SUCH A MANNER AS TO PREVENT SEGREGATION OF THE STONE SIZES.
5. STONE FOR RIPRAP SHALL BE ANGULAR OR SUBANGULAR. THE STONES SHOULD BE SHAPED SO THAT THE LEAST DIMENSION OF THE STONE FRAGMENT SHALL BE NOT LESS THAN ONE-THIRD OF THE GREATEST DIMENSION OF THE FRAGMENT.
6. FLAT ROCKS SHALL NOT USED FOR RIP RAP. VOIDS IN THE ROCK RIPRAP SHOULD BE FILLED WITH SPALLS AND SMALLER ROCKS.

**MAINTENANCE**


1. THE OUTLET PROTECTION SHOULD BE CHECKED AT LEAST ANNUALLY AND AFTER EVERY MAJOR STORM. IF THE RIP RAP HAS BEEN DISPLACED, UNDERMINED OR DAMAGED, IT SHOULD BE REPAIRED IMMEDIATELY. THE CHANNEL IMMEDIATELY BELOW THE OUTLET SHOULD BE CHECKED TO SEE THAT EROSION IS NOT OCCURRING. THE DOWNSTREAM CHANNEL SHOULD BE KEPT CLEAR OF OBSTRUCTIONS SUCH AS FALLEN TREES, DEBRIS, AND SEDIMENT THAT COULD CHANGE FLOW PATTERNS AND/OR TAILWATER DEPTHS ON THE PIPES. REPAIRS MUST BE CARRIED OUT IMMEDIATELY TO AVOID ADDITIONAL DAMAGE TO OUTLET PROTECTION.

**PIPE OUTLET PROTECTION**

TRAFFIC CONTROL SCHEDULE					
SIGN NUMBER	SIGN	SIZE OF SIGN WIDTH HEIGHT	DESCRIPTION	MOUNT TYPE	MOUNT HEIGHT
R1-1	STOP	30" x 30"	WHITE ON RED	CHANNEL	7'-0"
R2-1	SPEED LIMIT 25	18" x 24"	BLACK ON WHITE	CHANNEL	7'-0"
W14-2	NO OUTLET	24" x 24"	BLACK ON YELLOW	CHANNEL	7'-0"

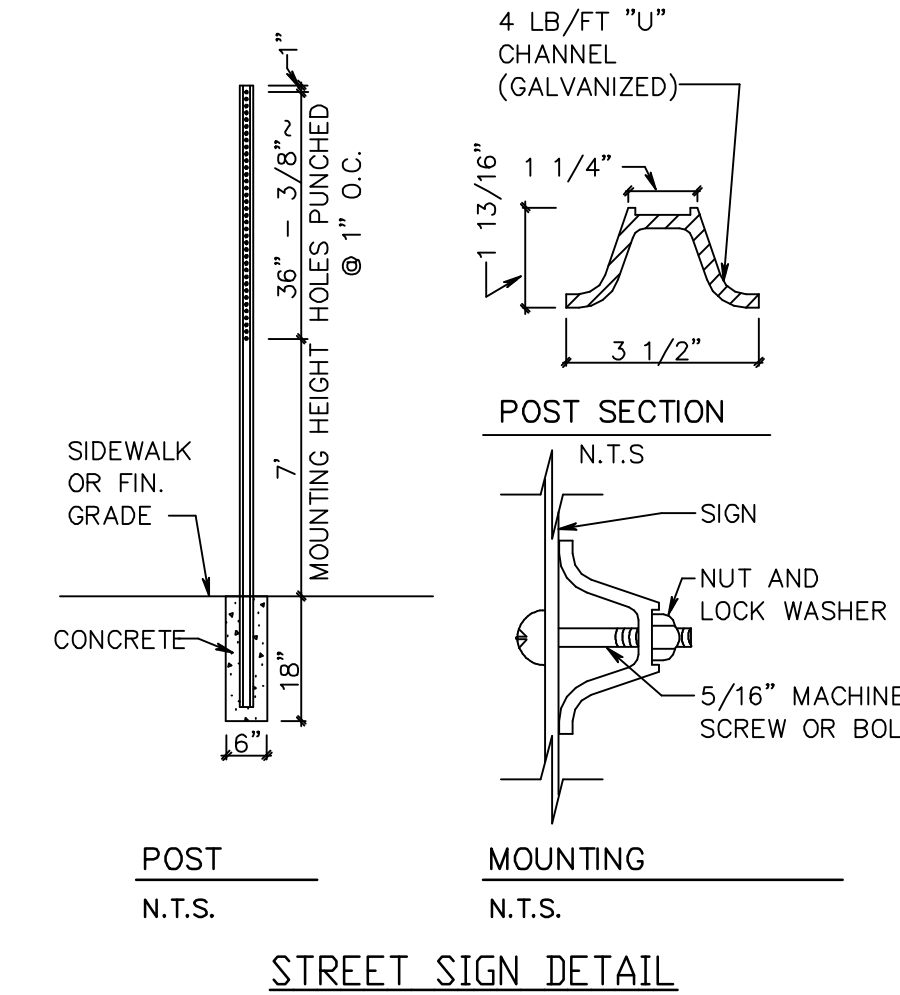


**STREET SIGN DETAIL**

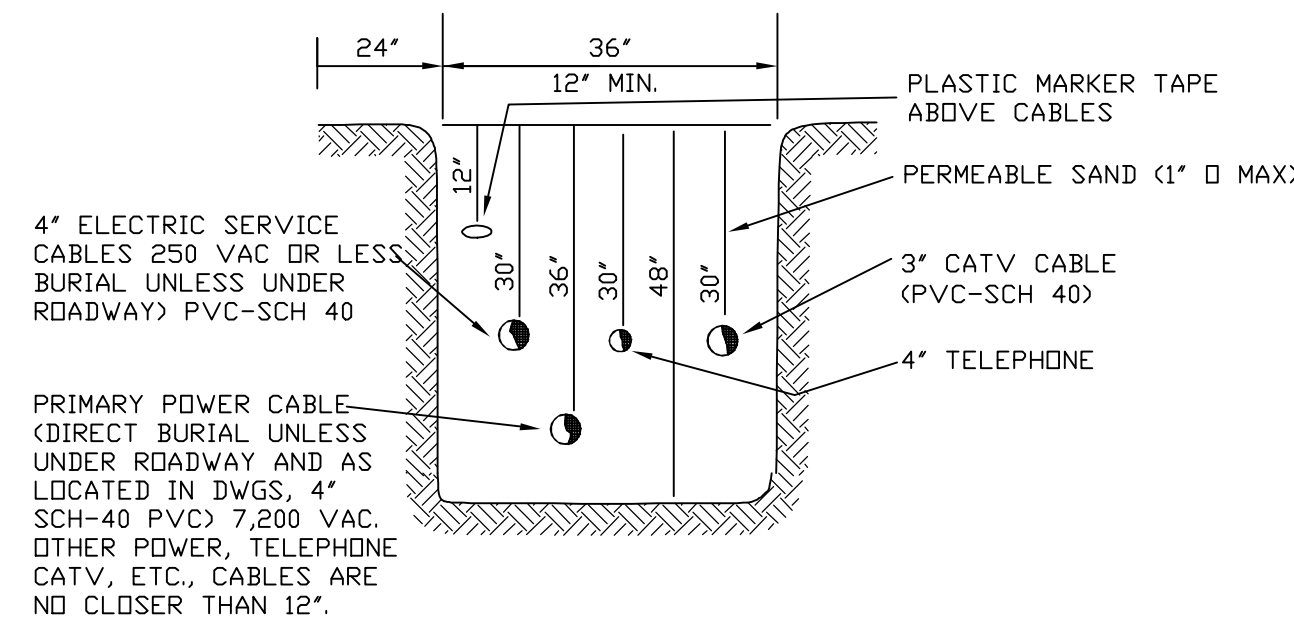


**UTILITY TRENCH DETAIL**

NOTE: ALL UTILITIES SHALL BE REVIEWED AND APPROVED BY APPROPRIATE UTILITY COMPANY. SERVICE BOX CONNECTIONS SHALL BE FLUSH MOUNT TO GREATEST EXTENT POSSIBLE AND LOCATED AT PROPERTY LINE CORNERS.

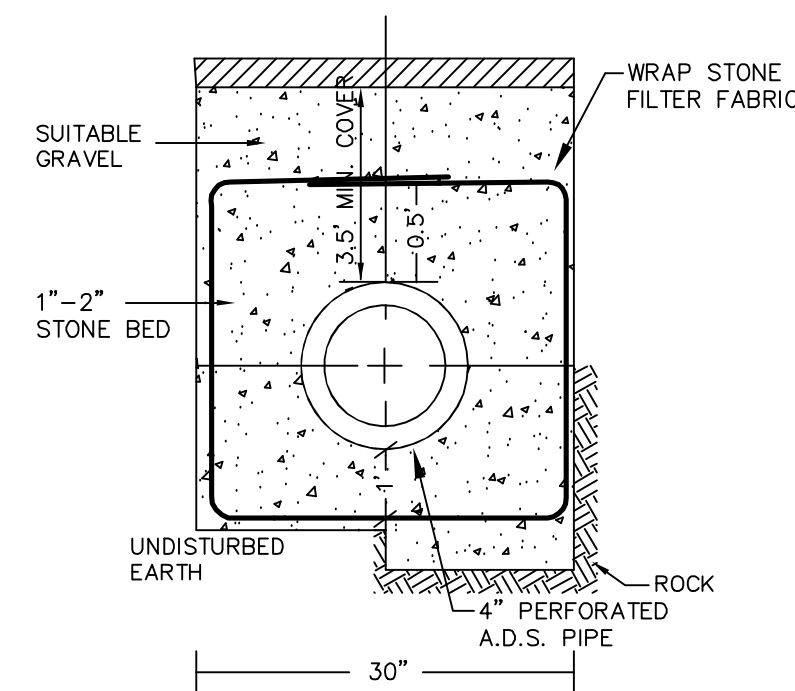

**UNDERDRAIN TRENCH DETAIL**  
NOT TO SCALE

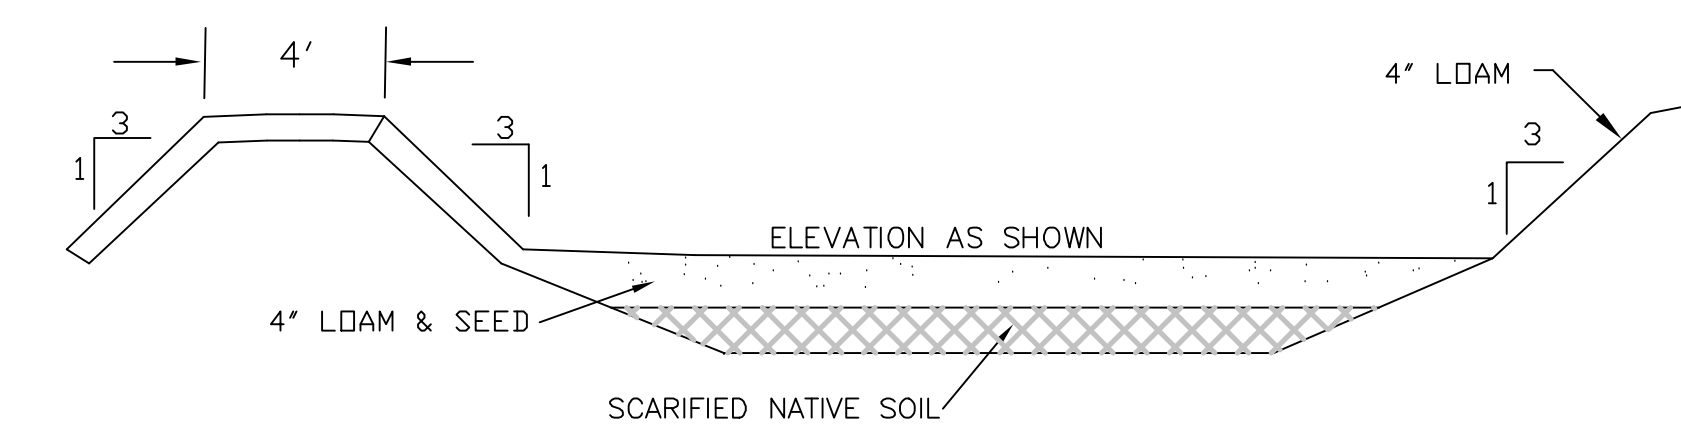


**INFILTRATION POND NOTES:**

1. DO NOT TRAFFIC EXPOSED SOIL SURFACE WITH CONSTRUCTION EQUIPMENT. IF FEASIBLE, PERFORM EXCAVATION WITH EQUIPMENT POSITIONED OUTSIDE THE LIMITS OF THE INFILTRATION SYSTEM.
2. AFTER THE INFILTRATION SYSTEM AREA IS EXCAVATED TO THE FINAL DESIGN ELEVATION, THE FLOOR SHOULD BE DEEPLY TILLED WITH A ROTARY TILLER OR DISC HARROW TO RESTORE INFILTRATION RATES, FOLLOWED BY A PASS WITH A LEVELING DRAG.
3. DO NOT PLACE INFILTRATION SYSTEM INTO SERVICE UNTIL THE CONTRIBUTING AREAS HAVE BEEN FULLY STABILIZED.
4. SEED SHALL BE NEW ENGLAND EROSION CONTROL/RESTORATION MIX FOR DETENTION BASINS AND MOIST SITES BY NEW ENGLAND WETLAND PLANTS OR EQUAL.

**INFILTRATION POND DETAIL**


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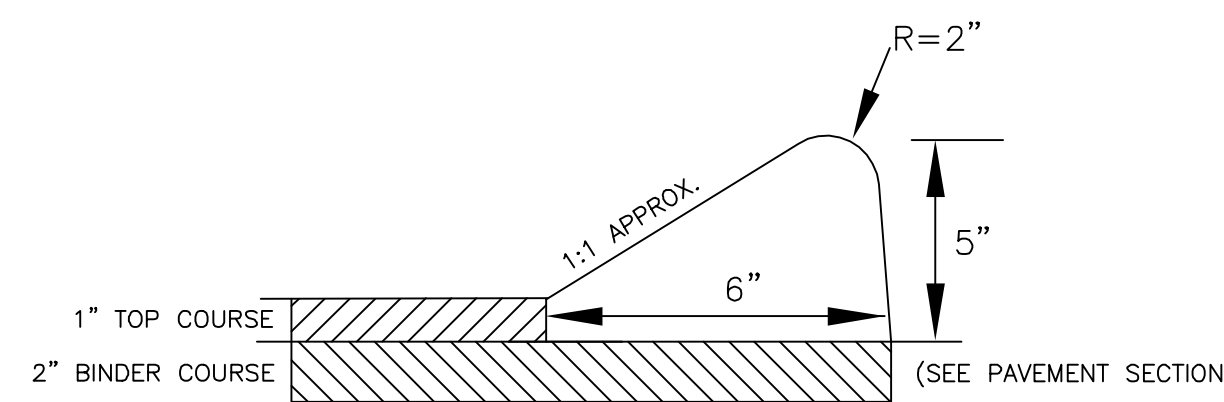
**NOTE:**

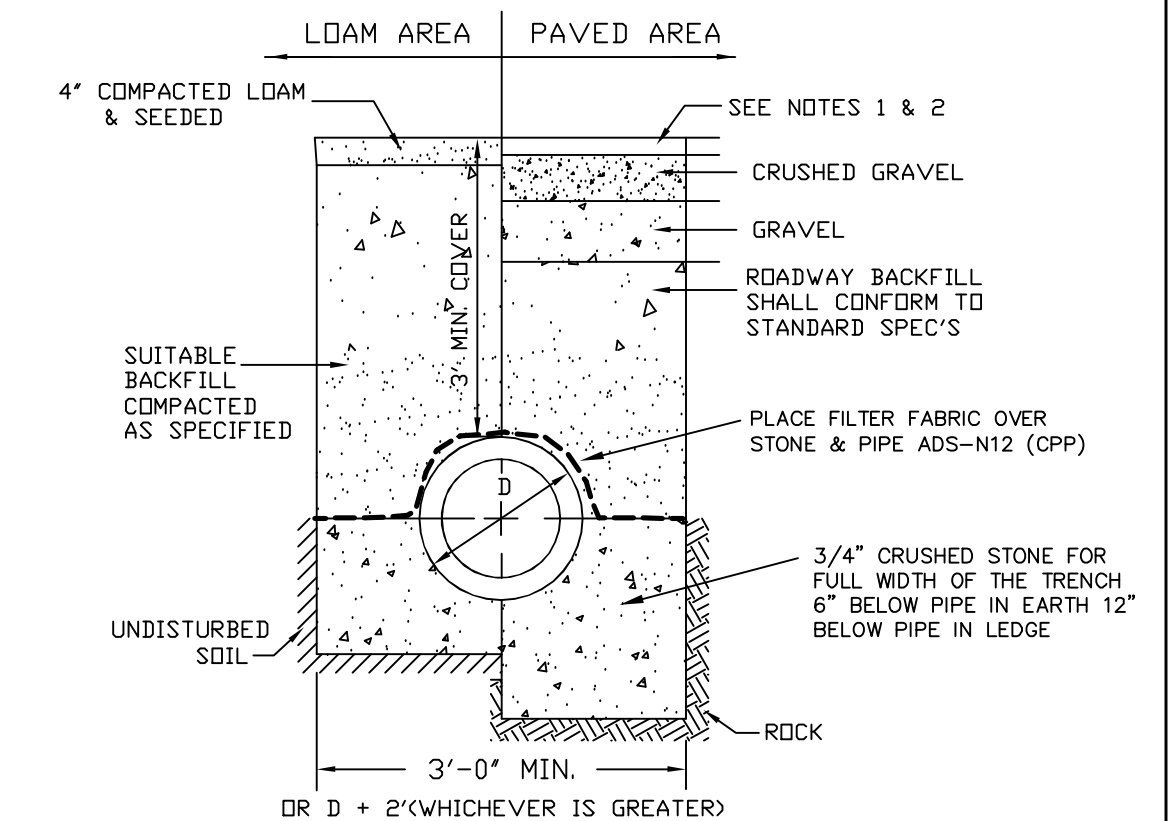1. PAVEMENT REPAIR IN EXISTING ROADWAYS SHALL CONFORM TO STREET OPENING REGULATIONS.
2. NEW ROADWAY CONSTRUCTION SHALL CONFORM TO SUBDIVISION SPEC'S.

**TYPICAL DRAINAGE TRENCH DETAIL**




**TYPICAL TRENCH DETAIL FOR WATER SYSTEM**

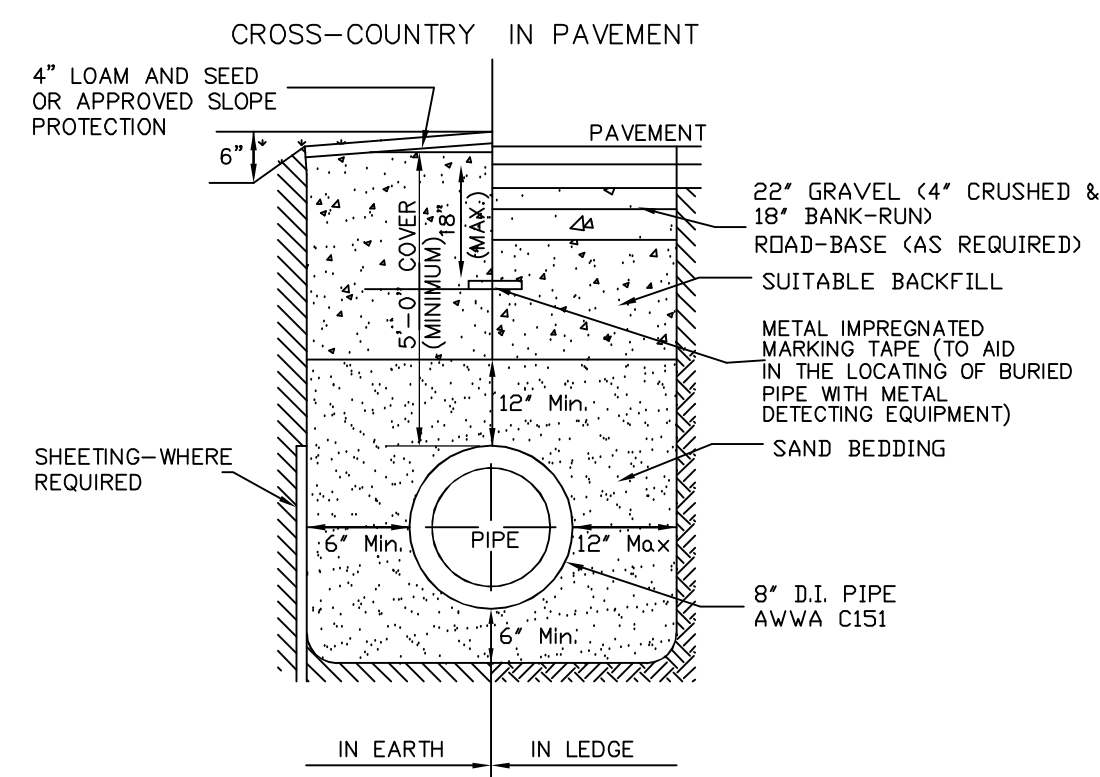

**CAPE COD BERM DETAIL**

NOT TO SCALE

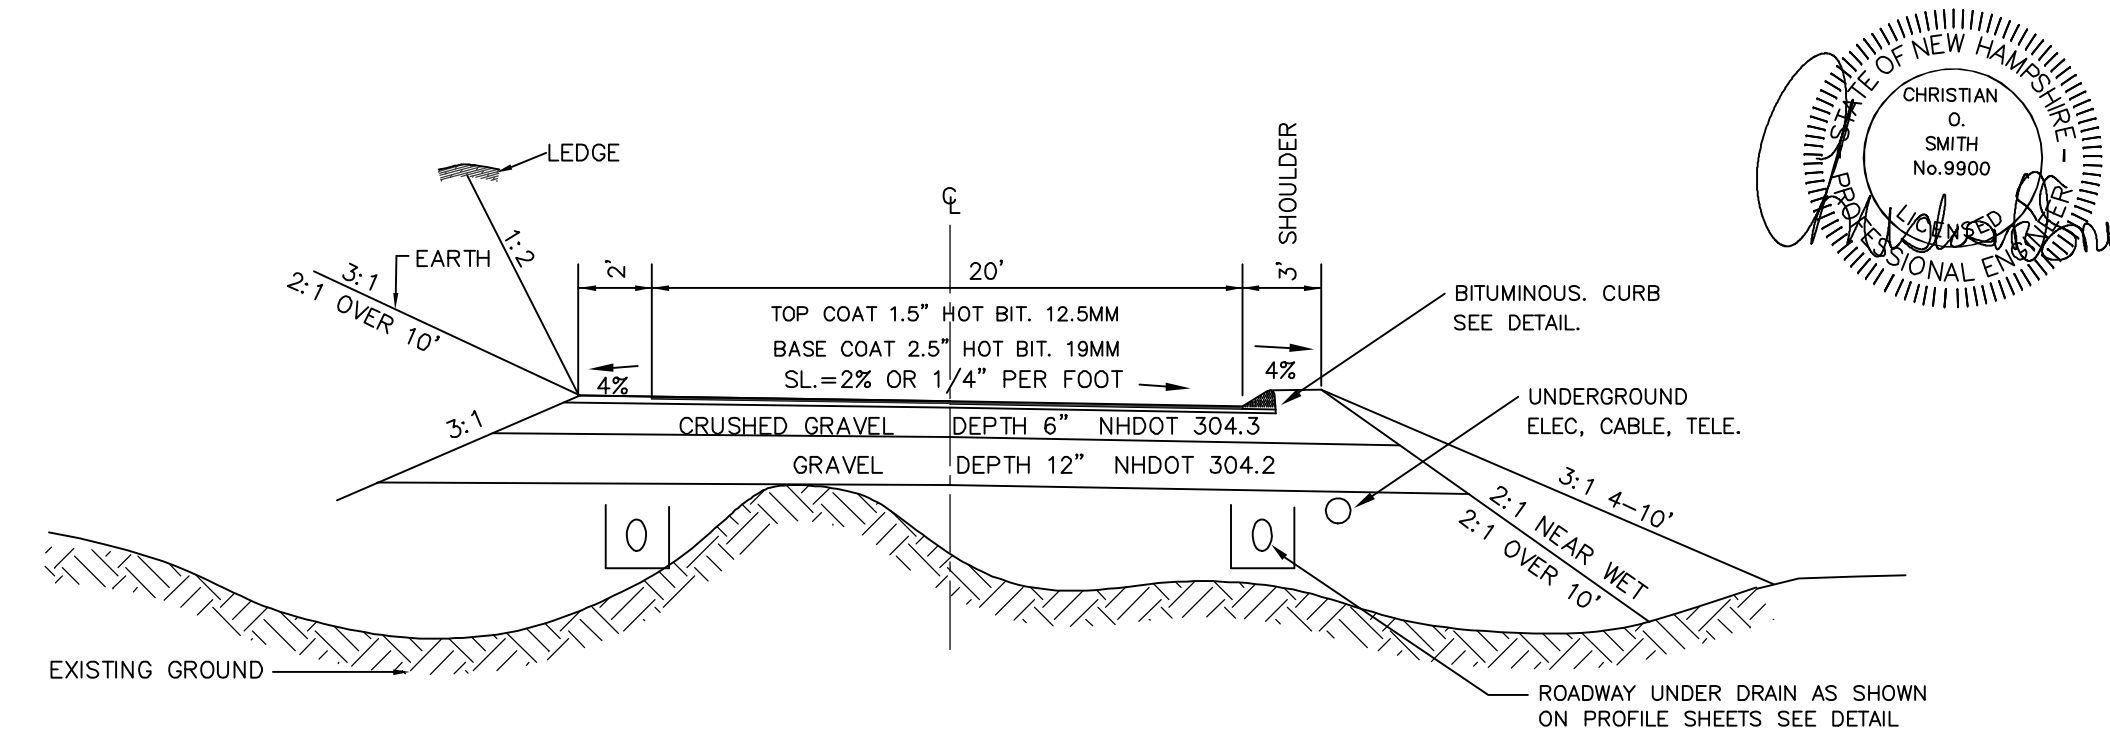

**TYPICAL DRIVEWAY CROSS SECTION**

NOT TO SCALE

PREPARED FOR:

RED BARN PROPERTY LLC  
6 SHORE DRIVE  
GREENLAND, NH 03840



70 PORTSMOUTH AVE,  
THIRD FLOOR, SUITE 2  
STRATHAM, N.H. 03885  
PHONE: 603-583-4860.

REVISED PER REVIEW COMMENTS	05/05/26
REVISIONS:	DATE:

**CONSTRUCTION DETAILS D1**

PLAN FOR:  
RESIDENTIAL DEVELOPMENT  
210 PORTSMOUTH AVE  
STRATHAM, NH

DATE: MAR 11, 2026	SCALE: NTS
PROJ. NO: NH-1566	SHEET NO: 10

**NOTES**

1. THE LOCATIONS OF LIMITED COMMON AREAS ARE APPROXIMATE AND WILL BE FINALIZED AFTER CONSTRUCTION BY NORTHAM SURVEY LLC TO BE RECORDED AT THE REGISTRY OF DEEDS.
2. UNIT NUMBERING IS FOR CONVENIENCE AND CLARITY ONLY. ACTUAL UNIT NUMBERS WILL BE DECIDED BY THE TOWN OF STRATHAM.
3. ALL AREA NOT NOTED AS LIMITED COMMON AREA SHALL BE COMMON AREA.



LCA = LIMITED COMMON AREA

PREPARED FOR:


RED BARN PROPERTY LLC  
6 SHORE DRIVE  
GREENLAND, NH 03840



70 PORTSMOUTH AVE,  
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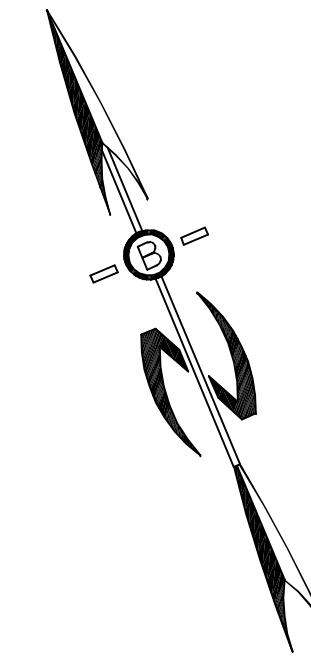
COMMON  
(EXTENSIVE)  
REAR  
PROPE

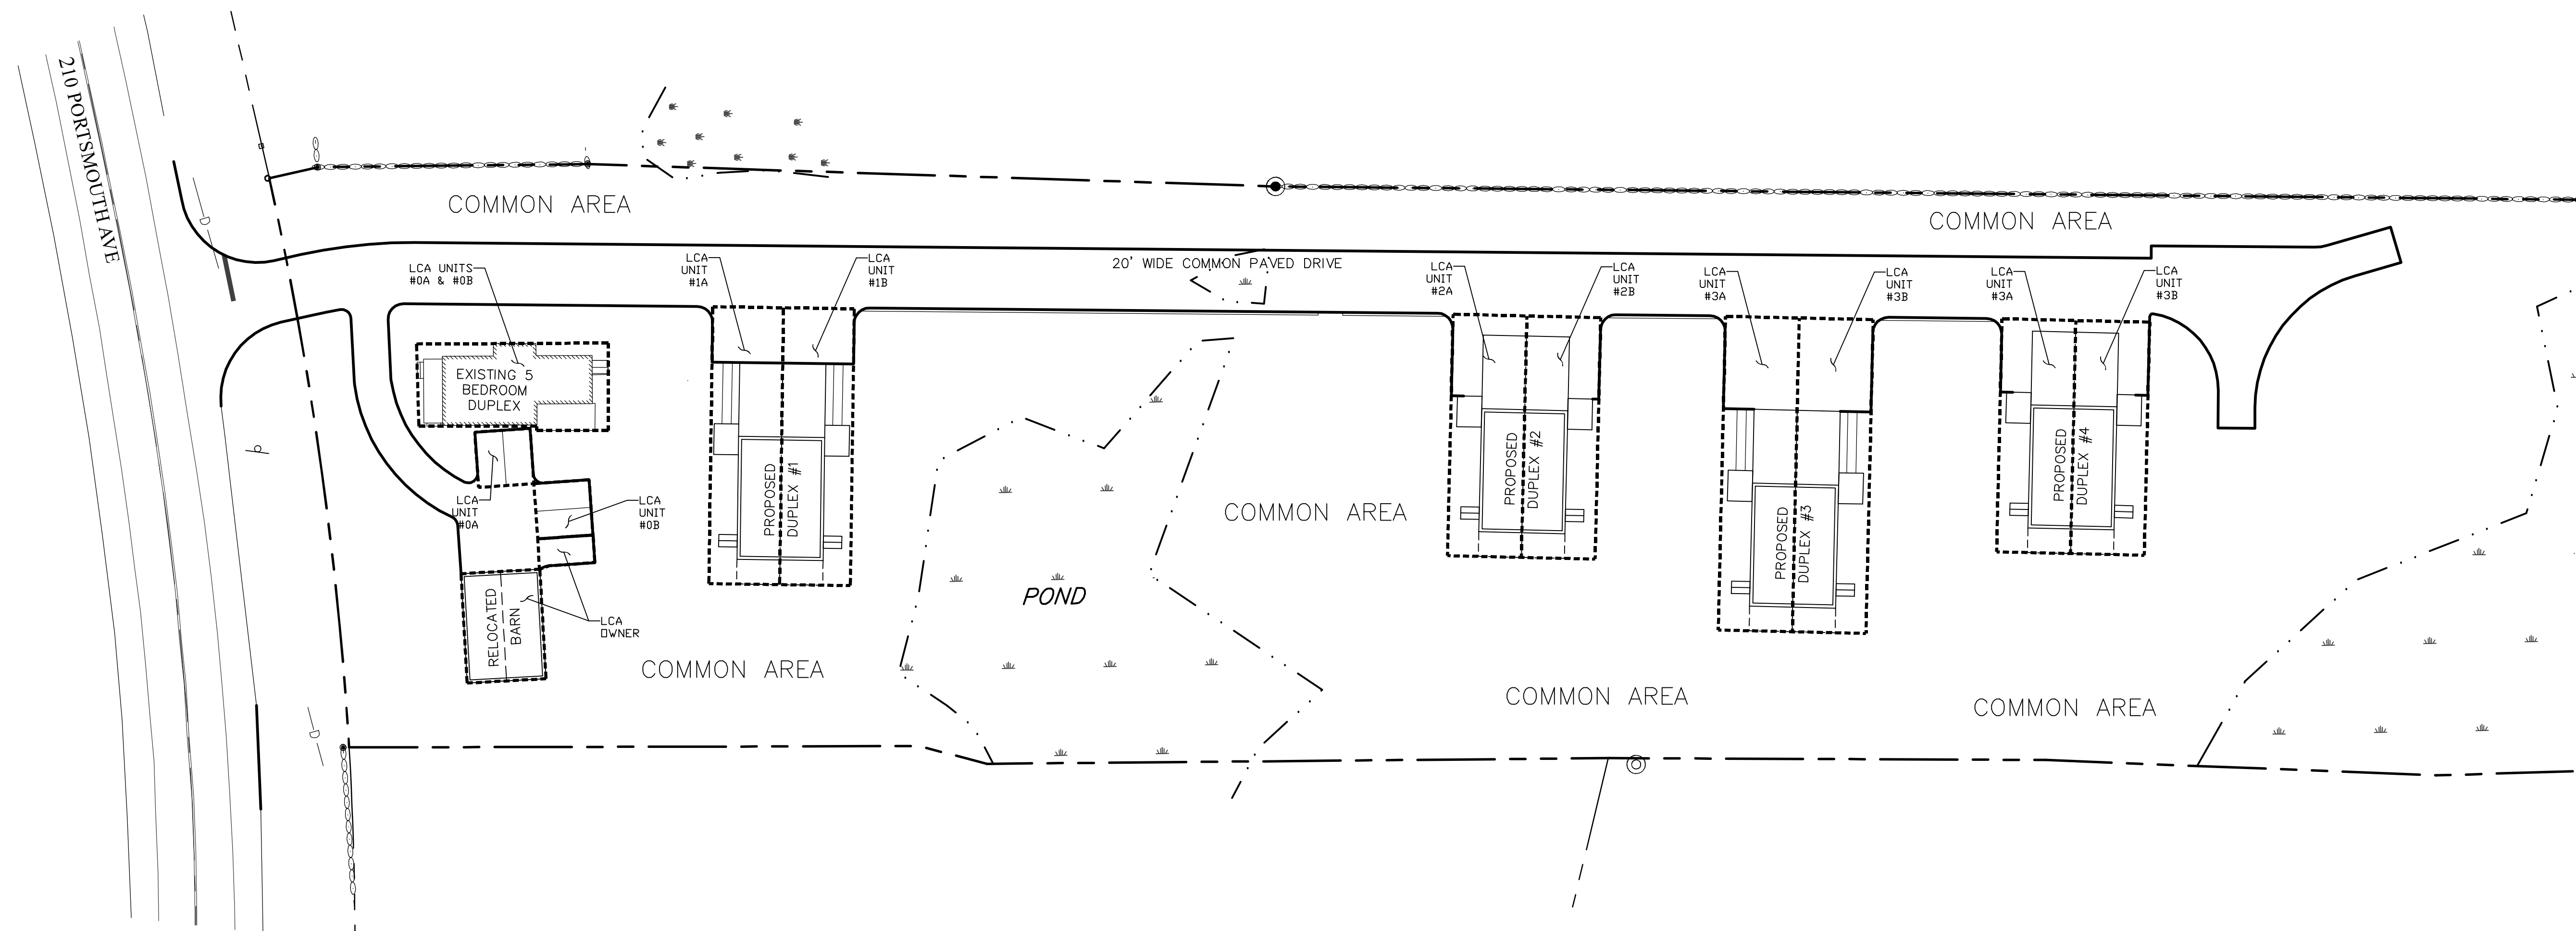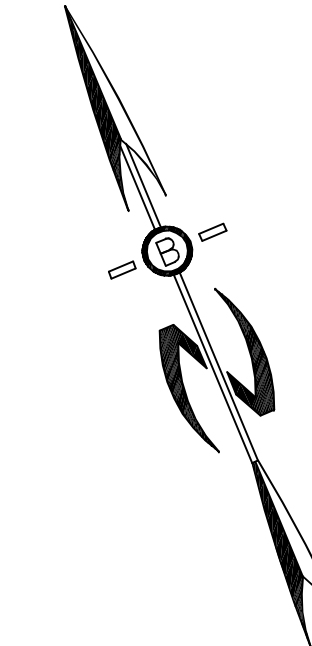

REVISIONS:		DATE:	
<b>DRAFT CONDOMINIUM SITE PLAN</b>			
PLAN FOR: RESIDENTIAL DEVELOPMENT 210 PORTSMOUTH AVE STRATHAM, NH			
DATE:	MAR 23, 2026	SCALE:	1"=30'
PROJ. NO.:	NH-1566	SHEET NO.:	11

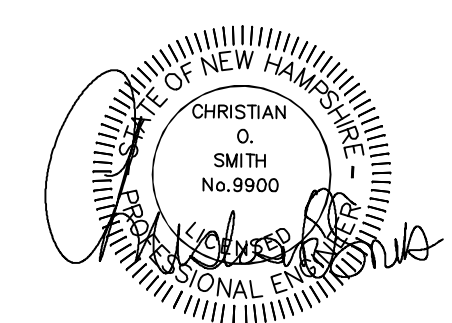LEGEND

- 0-25' NO DISTURBANCE ZONE ENHANCEMENTS
- 25-75' WETLAND SETBACK ENHANCEMENT PLANTINGS (APPROXIMATELY 8- FEET ON CENTER)
- BOULDER PILES
- NEST BOXES (APPROXIMATELY EVERY 40 FEET)



PREPARED FOR:  
**RED BARN PROPERTY LLC**  
 6 SHORE DRIVE  
 GREENLAND, NH 03840

**BA**  
**BEALS**  
 ASSOCIATES, PLLC

70 PORTSMOUTH AVE,  
 THIRD FLOOR, SUITE 2  
 STRATHAM, N.H. 03885  
 PHONE: 603-583-4860.



REVISIONS:	DATE:		
<b>BUFFER ENHANCEMENT PLAN</b>			
PLAN FOR: RESIDENTIAL DEVELOPMENT 210 PORTSMOUTH AVE STRATHAM, NH			
DATE:	MAR 23, 2026	SCALE:	1"=30'
PROJ. NO:	NH-1566	SHEET NO.	12